
BONNER COUNTY, IDAHO


### **CONTACT:**

OWNER: DEERFIELD, LLC 615 LAKEVIEW BLVD SANDPOINT, ID 83864 PH: 208-290-9090

A PORTION OF NE1/4 OF THE SW1/4 SECTION 16, TOWNSHIP 57 NORTH, RANGE 2 WEST BOISE PRINCIPAL MERIDIAN, BONNER COUNTY, IDAHO

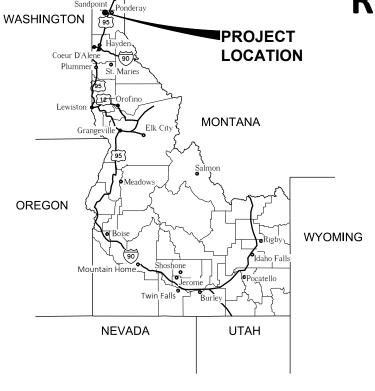

CONTACTS			
COUNTY	BONNER COUNTY	208-255-3630	
SEWER DISTRICT	PANHANDLE HEALTH DISTRICT	208-265-6384	
WATER DISTRICT	SYRINGA HEIGHTS WATER DISTRICT	208-290-2126	
FIRE DISTRICT	NORTHSIDE FIRE DISTRICT	208-265-4114	

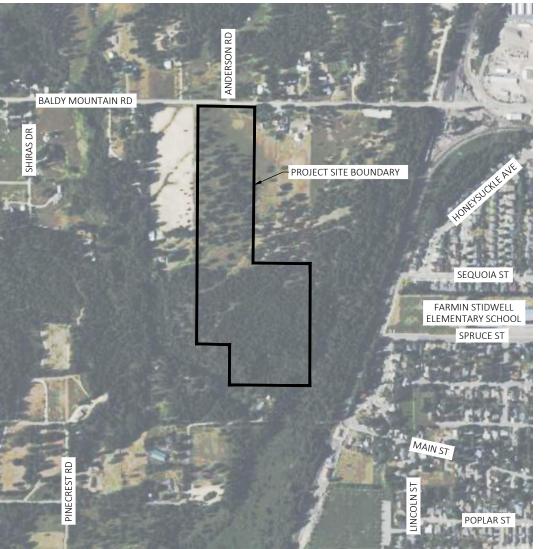

### STORMWATER CALCULATIONS AND ASSUMPTIONS:

STORMWATER ASSUMPTIONS INCLUDE 24 RESIDENTIAL LOTS, EACH INCLUDING AN IMPERVIOUS AREA OF 5,000 SF PER LOT.

DRIVEWAY CULVERTS WERE MODELED FOR THE FOLLOWING: BLOCK 1, LOTS 1-5 & 11-13 SINGLE 12" DIAMETER CULVERT: BLOCK 2, LOTS 1-5 & 10-11 DOUBLE 12" DIAMETER CULVERT: BLOCK 1, LOTS 6-10

ALL CREATED IMPERVIOUS SURFACES SHALL BE GRADED TO DRAIN TO THE DEERFIELD DRIVE ROADSIDE DITCH.

BLOCK 2, LOTS 6-9


SHEET INDEX TABLE				
DRAWING NUMBER	SHEET TITLE	STATION		
C0.00	COVER SHEET			
C0.01	PROJECT NOTES			
C1.00	ROAD OVERALL PLAN & LEGEND			
C1.01	ROAD PLAN AND PROFILE	STA0+50 TO STA. 4+75		
C1.02	ROAD PLAN AND PROFILE	STA. 4+75 TO STA. 10+00		
C1.03	ROAD PLAN AND PROFILE	STA. 10+00 TO STA. 15+00		
C1.04	ROAD PLAN AND PROFILE	STA. 15+00 TO STA. 17+50		
C1.05	ROAD PLAN AND PROFILE	STA. 17+50 TO STA. 20+50		
C1.06	ROAD PLAN AND PROFILE	STA. 20+50 TO STA. 23+00		
C1.07	ROAD PLAN AND PROFILE	STA. 23+00 TO STA. 26+00		
C1.08	ROAD PLAN AND PROFILE	STA. 26+00 TO STA. END		
C1.09	ROAD SECTIONS			
C1.10	INTERSECTION PLAN AND ROAD DETAILS			
C1.11	OVERALL GRADING, EROSION AND SEDIMENT CONTROL PLAN			
C1.12	STORMWATER POND DETAILED GRADING PLAN			
C1.13	LOTS 5 AND 6 DETAILED GRADING PLAN			
C1.14	WATER TANK SITE CROSS SECTION			
C1.15	EROSION AND SEDIMENT CONTROL DETAILS			
C1.16	STORMWATER DETAILS			
C1.17	STORMWATER DETAILS			



476864 Highway 95, Suite 3 Ponderay, ID 83852 (208) 635-5825

EERFIELD BONNER COUNTY,

**COVER SHEET** 

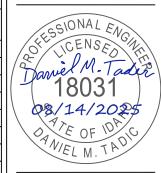

### **CONSTRUCTION DOCUMENTS**

SCALE: (11X17 ONLY)

DWG: D24013 - C1.05 ROAD P&P.DWG PROJECT NO: D24013 DRAWN BY: CHECKED BY: DMT

DATE:


AUGUST 2025

REVISIONS

NO. DATE BY DESCRIPTION

**DRAWING:** 

SHEET: 1 OF 20

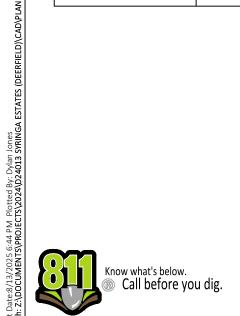



### **GENERAL NOTES:**

- ALL WORK SHALL CONFORM TO THE IDAHO STANDARDS FOR PUBLIC WORKS CONSTRUCTION (ISPWC) CURRENT EDITION AND BONNER COUNTY ROAD STANDARDS MANUAL (2019). IN THE EVENT OF A CONFLICT, THE MORE STRINGENT REQUIREMENT SHALL APPLY.
- CLEAR AND GRUB TO THE LIMITS SHOWN ON THE PLANS AND IN ACCORDANCE WITH ISPWC SECTION 201. REMOVE ALL DEBRIS, TREES, STUMPS, BRUSH, GRASSES, ROOTS, ORGANIC SOIL, EXISTING FILL OR ANY OTHER DELETERIOUS MATERIAL AS INDICATED. ONSITE DISPOSAL OF ORGANIC MATERIALS IS NOT ALLOWED WITHOUT WRITTEN CONSENT OF THE OWNER.
- EXISTING PROPERTY CORNERS OR SURVEY MONUMENTS SHALL BE PROTECTED DURING THE COURSE OF CONSTRUCTION. ANY DAMAGED OR OBLITERATED CORNERS SHALL BE RE-ESTABLISHED BY PROFESSIONAL SURVEYORS, LICENSED TO WORK IN THE STATE OF IDAHO. PRIOR TO FINAL ACCEPTANCE. AT THE CONTRACTOR'S EXPENSE.
- 4. EXISTING UTILITIES SHALL BE LOCATED BY CONTACTING CALL BEFORE YOU DIG AT 811, AT LEAST 48 HOURS PRIOR TO STARTING ANY EARTHWORK ACTIVITY. THE CONTRACTOR SHALL NOTIFY THE APPROPRIATE UTILITY PROVIDERS PRIOR TO STARTING ANY WORK NEAR ANY FACILITIES AND SHALL COORDINATE THEIR WORK WITH COMPANY REPRESENTATIVES.
- 5. THE CONTRACTOR SHALL MAINTAIN STREETS, SIDEWALKS, AND ALL OTHER PUBLIC RIGHT-OF-WAY IN A CLEAN, SAFE AND USEABLE CONDITION. ALL SOIL, ROCK, OR CONSTRUCTION DEBRIS SHALL BE PROMPTLY REMOVED FROM THE PUBLICLY OWNED PROPERTY DURING CONSTRUCTION AND UPON COMPLETION OF THE PROJECT. ALL ADJACENT PROPERTY; PRIVATE OR PUBLIC, SHALL BE MAINTAINED IN A CLEAN, SAFE AND USEABLE CONDITION.
- 6. A NOTICE OF INTENT (NOI) WITH THE IDAHO DEPARTMENT OF ENVIRONMENTAL QUALITY (IDEQ) SHALL BE FILED. A COPY OF THE STORM WATER POLLUTION PREVENTION PLAN (SWPPP) AND NOI SHALL BE PROVIDED TO THE ENGINEER PRIOR TO THE START OF CONSTRUCTION AND MAINTAINED ON SITE FOR THE DURATION OF CONSTRUCTION.
- 7. THE CONTRACTOR SHALL BE RESPONSIBLE FOR ALL PROPOSED TRAFFIC CONTROL IN ACCORDANCE WITH THE MUTCD CURRENT EDITION, STATE OF IDAHO AND BONNER COUNTY REQUIREMENTS. AT LEAST 48 HOURS PRIOR TO ANY PROPOSED TRAFFIC DISRUPTION, CONTRACTOR SHALL PREPARE AND SUBMIT TRAFFIC CONTROL PLANS TO THE ENGINEER FOR APPROVAL. NO WORK SHALL COMMENCE UNTIL APPROVAL IS GRANTED AND ALL APPROVED TRAFFIC CONTROL IS IN PLACE.
- THE CONTRACTOR SHALL BE RESPONSIBLE FOR ALL PROJECT INSPECTIONS AND TESTS, INCLUDING MATERIALS TESTING AND QUALITY CONTROL. AS-BUILT DRAWINGS SHALL BE SUBMITTED TO BONNER COUNTY ROAD AND BRIDGE PRIOR TO FINAL ACCEPTANCE.

### **EARTHWORK AND GRADING NOTES:**

- 1. ALL CUTS AND FILLS SHALL BE CONFINED TO THE LIMITS INDICATED ON THE PLANS.
- 2. EXCAVATED MATERIAL MAY BE INCORPORATED INTO THE WORK AT THE DISCRETION OF THE ENGINEER.
- 3. THE CONTRACTOR SHALL ENSURE THAT ALL TEMPORARY SLOPES ARE STABLE AND THAT APPROPRIATE EROSION CONTROL MEASURE ARE IN PLACE AND MAINTAINED.
- 4. DEWATERING IS THE RESPONSIBILITY OF THE CONTRACTOR
- 5. COMPACTION SHALL BE PERFORMED IN ACCORDANCE WITH ISPWC REQUIREMENTS. ALL COMPACTION EFFORTS SHALL BE MONITORED AND TESTED BY AN EXPERIENCED SOIL TECHNICIAN REPRESENTING THE CONTRACTOR.
- 6. ENGINEERED FILLS SHALL CONFORM TO THE REQUIREMENTS OF THE ISPWC, PLANS AND SPECIFICATIONS. THE ENGINEER SHALL REVIEW AND APPROVE ALL IMPORT AGGREGATE SOURCES AND PRODUCTS PRIOR TO INCORPORATION INTO THE WORK.
- 7. ALL FILL MATERIAL SHALL BE MOISTURE CONDITIONED TO WITHIN 2% OF OPTIMUM MOISTURE PRIOR TO PLACEMENT. LIFTS SHALL NOT EXCEED EIGHT INCHES. ALL FILL SHALL BE COMPACTED TO ISPWC OR PROJECT SPECIFICATIONS. ANY FILL MATERIAL TOO COARSE TO TEST, SHALL BE PLACED IN CONTROLLED LIFTS UNDER A PERFORMANCE-BASED METHOD, AS OUTLINED WITHIN THE ISPWC.
- 8. NO FILL SHALL BE PLACED ON FROZEN OR SNOW-COVERED GROUND. PLACEMENT OF FROZEN FILL IS NOT ALLOWED.
- FILL PLACED ON SLOPES GREATER THAN 3 HORIZONTAL TO 1 VERTICAL SHALL BE KEYED INTO THE UNDISTURBED GROUND WITH HORIZONTAL BENCHES HAVING A VERTICAL FACE APPROXIMATELY 1 FOOT IN HEIGHT. SLOPE EACH BENCH TO DRAIN.
- 10. PRIOR TO PLACING FILL WITHIN THE ROADWAY PRISM, THE FOLLOWING SHALL BE COMPLETED:
  - a) ALL PUBLIC UTILITIES SHALL BE INSTALLED, TESTED AND APPROVED.
  - b) THE CONTRACTOR SHALL PROVIDE COPIES OF COMPACTION TEST RESULTS TO THE ENGINEER OF RECORD, FOR ALL TRENCHES AND SUBGRADE AS APPLICABLE.
  - c) SUBGRADE SHALL BE INSPECTED AND APPROVED BY THE ENGINEER OF RECORD.
  - d)PROOF-ROLL SUBGRADE SHALL BE AT THE DISCRETION OF THE ENGINEER OF
  - e) OBTAIN AUTHORIZATION FROM THE ENGINEER OF RECORD AND BONNER COUNTY ROAD AND BRIDGE DIRECTOR OR HIS DESIGNEE TO PROCEED WITH PLACEMENT OF BASE MATERIAL. BONNER COUNTY SHALL BE NOTIFIED AT LEAST 24 HOURS TO PLACEMENT OF BASE MATERIAL.
- 11. IMPORTED FILL MATERIAL SHALL CONFORM TO THE FOLLOWING:
  - a) BASE COURSE (BALLAST) SHALL BE IN ACCORDANCE WITH THE BONNER COUNTY ROAD STANDARDS MANUAL AND MEET THE FOLLOWING GRADATION:

SIEVE SIZE	PERCENT PASSING	
6 INCH	100	
3 INCH	98 - 100	
2 INCH	75 - 100	
1 INCH	40 - 80	
#4	25 - 60	
#200	5 - 12	

b) TOP COURSE SHALL IN ACCORDANCE WITH THE BONNER COUNTY ROAD STANDARDS MANUAL AND MEET THE FOLLOWING GRADATION:

SIEVE SIZE	PERCENT PASSING	
1 INCH	100	
3/4 INCH	90 - 100	
#4	40 - 65	
#8	30 - 50	
#200	3 - 9	

- 12. PRIOR TO PLACING TOP COURSE ON THE BALLAST, OBTAIN AUTHORIZATION FROM THE ENGINEER OF RECORD AND BONNER COUNTY ROAD AND BRIDGE DIRECTOR OR HIS DESIGNEE.
- 13. PRIOR TO REQUESTING OBSERVATION OF THE FINISHED BALLAST, RED TOP STAKES SET TO FINISHED BALLAST ELEVATION, SHALL BE PLACED AT FIFTY FOOT (50') STATIONING ON CURVES AND ONE HUNDRED FOOT (100') STATIONING ON TANGENTS AT CENTERLINE AND SHOULDERS.
- 14. PRIOR TO REQUESTING OBSERVATION OF THE FINISHED TOP COURSE MATERIAL, BLUE TOP STAKES WILL BE SET TO FINISHED BASE ELEVATIONS AT FIFTY FOOT (50') STATIONING ON CURVES AND ONE HUNDRED FOOT (100') STATIONING ON TANGENTS AT CENTERLINE AND SHOULDERS.
- 15. THE SURFACE OF ANY BASE COURSE, WHEN FINISHED, SHALL BE SUCH THAT WHEN TESTED WITH A TEN FOOT (10') STRAIGHTEDGE PLACED ON THE SURFACE WITH ITS CENTERLINE PARALLEL TO AND PERPENDICULAR TO THE CENTERLINE OF THE ROAD, THE MAXIMUM DEVIATION FROM THE SURFACE OF THE EDGE OF THE STRAIGHTEDGE SHALL NOT EXCEED 0.04 FEET. IN ADDITION, THE FINISHED EDGE SHALL NOT DEVIATE MORE THAN 0.03 FEET AT ANY POINT FROM THE STAKED ELEVATION.

### **HOT MIX SURFACING NOTES:**

- 1. ASPHALT PAVEMENT SHALL CONFORM WITH IDAHO TRANSPORTATION DEPARTMENT (ITD) SPECIFICATIONS FOR SUPERPAVE. PAVEMENT SHALL BE SP3 PG 58-28 WITH ½" MAX AGGREGATE SIZE. PAVEMENTS WITH A SECTION OF 3" OF LESS MAY BE PLACED IN ONE LIFT. PAVEMENTS WITH A SECTION GREATER THAN 3" SHALL BE PLACED IN MULTIPLE LIFTS. MINIMUM LIFT THICKNESS OF 1.5" AND MAXIMUM LIFT THICKNESS OF 3". MIX DESIGN MUST BE SUBMITTED TO BONNER COUNTY ROAD AND BRIDGE FOR APPROVAL.
- NO ASPHALT SHALL BE PLACED ON WET OR FROZEN GROUND, OR WHEN THE AIR
  OR GROUND TEMPERATURE IS LESS THAN 45 DEGREES FAHRENHEIT AND RISING
  AND THE MIX IS AT A TEMPERATURE NOT LESS THAN 235 DEGREES FAHRENHEIT
  AND NOT TO EXCEED 280 DEGREES FAHRENHEIT.
- . AFTER SPREADING, THE MIXTURE SHALL BE THOROUGHLY AND UNIFORMLY COMPACTED WITH POWER ROLLERS IN ACCORDANCE WITH BONNER COUNTY ROAD STANDARDS MANUAL SECTION 6.20.D.
- 4. DURING PAVING OPERATIONS, THE CONTRACTOR IS RESPONSIBLE FOR COMPACTION AND QUALITY CONTROL TESTING. ALL TESTING SHALL BE PERFORMED BY A QUALIFIED TECHNICIAN. THE COMPLETED HOT MIX ASPHALT CONCRETE SURFACE SHALL HAVE A FIELD DENSITY EQUAL TO OR GREATER THAN 92% RICE DENSITY. THREE OR MORE CONSECUTIVE TESTS BELOW 92% WILL REQUIRE CORRECTIVE ACTION.
- EXTRACTION CORING AND GRADATION TESTS MAY BE REQUIRED AT THE DISCRETION OF BONNER COUNTY TO VERIFY PAVEMENT THICKNESS, COMPACTION AND MATERIALS.
- 6. THE FINAL SURFACE SHALL BE OF A UNIFORM TEXTURE AND SHALL CONFORM TO LINES AND GRADES SHOWN ON THE PLANS. BOTH DENSITY AND THICKNESS SHALL BE CAREFULLY CONTROLLED DURING CONSTRUCTION AND SHALL BE IN FULL COMPLIANCE WITH THE PLANS AND SPECIFICATIONS. ALL UNSATISFACTORY WORK SHALL BE REPAIRED, REPLACED, OR CORRECTED.
- 7. A 10 FOOT STRAIGHTEDGE SHALL BE USED TO TEST THE FINISHED SURFACE IN SUCCESSIVE POSITIONS, PARALLEL AND PERPENDICULAR TO THE STREET CENTERLINE, IN CONTACT WITH THE SURFACE AND THE ENTIRE AREA CHECKED FROM ONE SIDE TO THE OTHER. ADVANCES ALONG THE PAVEMENT SHALL BE IN SUCCESSIVE STAGES OF NOT MORE THAN THE LENGTH OF THE STRAIGHTEDGE.
- 8. IRREGULARITIES WHICH MAY DEVELOP BEFORE THE COMPLETION OF ROLLING SHALL BE REMEDIED BY LOOSENING THE SURFACE MIX AND REMOVING OR ADDING MATERIALS AS MAY BE REQUIRED. ANY IRREGULARITIES OR DEFECTS WHICH ARE FOUND AFTER THE FINAL ROLLING, WHICH VARY MORE THAN 0.02 FEET IN 10 FEET FOR SURFACE COURSES SHALL BE CORRECTED. ALL MINOR SURFACE PROJECTIONS, JOINTS AND MINOR HONEYCOMBED SURFACES SHALL BE REPAIRED SMOOTH TO GRADE, AS MAY BE DIRECTED BY THE BONNER COUNTY ROAD AND BRIDGE DIRECTOR OR HIS DESIGNEE.

### **SIGNAGE AND STRIPING NOTES:**


- ALL WORK SHALL CONFORM TO THE IDAHO STANDARDS FOR PUBLIC WORKS CONSTRUCTION (ISPWC) CURRENT EDITION AND THE BONNER COUNTY ROAD STANDARDS MANUAL (2019). IN CASE OF CONFLICT, THE MOST STRINGENT STANDARD SHALL APPLY.
- PERMANENT TRAFFIC SIGNAGE SHALL BE STEEL POST IN ACCORDANCE WITH ISPWC SECTION 1105 AND SD-1130.
- 3. ALL PERMANENT SIGNAGE SHALL CONFORM TO THE MANUAL ON UNIFORM TRAFFIC CONTROL DEVICES (MUTCD) CURRENT EDITION. IN SHAPE, COLOR, AND SIZE.
- PERMANENT PAVEMENT MARKINGS SHALL BE IN ACCORDANCE WITH ISPWC SECTION 1104. ALL MARKINGS SHALL BE PAVEMENT PAINT (WATER BORNE) UNLESS NOTED OTHERWISE.



476864 Highway 95, Suite 3 Ponderay, ID 83852 (208) 635-5825

**DEERFIELD**ONNER COUNTY, II

PROJECT NOT

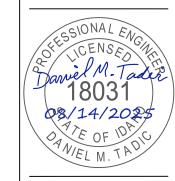

# CONSTRUCTION DOCUMENTS

SCALE: (11X17 ONLY)

DWG: D24013 - CO.O\_COVER.DWG
PROJECT NO: D24013
DRAWN BY: DJJ/DMH

CHECKED BY: DMT
DATE: AUGUST 2025

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REVISIONS

NO. DATE BY DESCRIPTION


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DRAWING:

**SHEET:** 2 **OF 20** 

Priot Dates:X 147,025 9:15 Priv Hotted By: Dylan Jones Part. 3 (DOC) IMENITY BROIECTEV 302 3/1074013 CVBINGS BARD. 3 - CO

Know what's below.
Call before you dig.



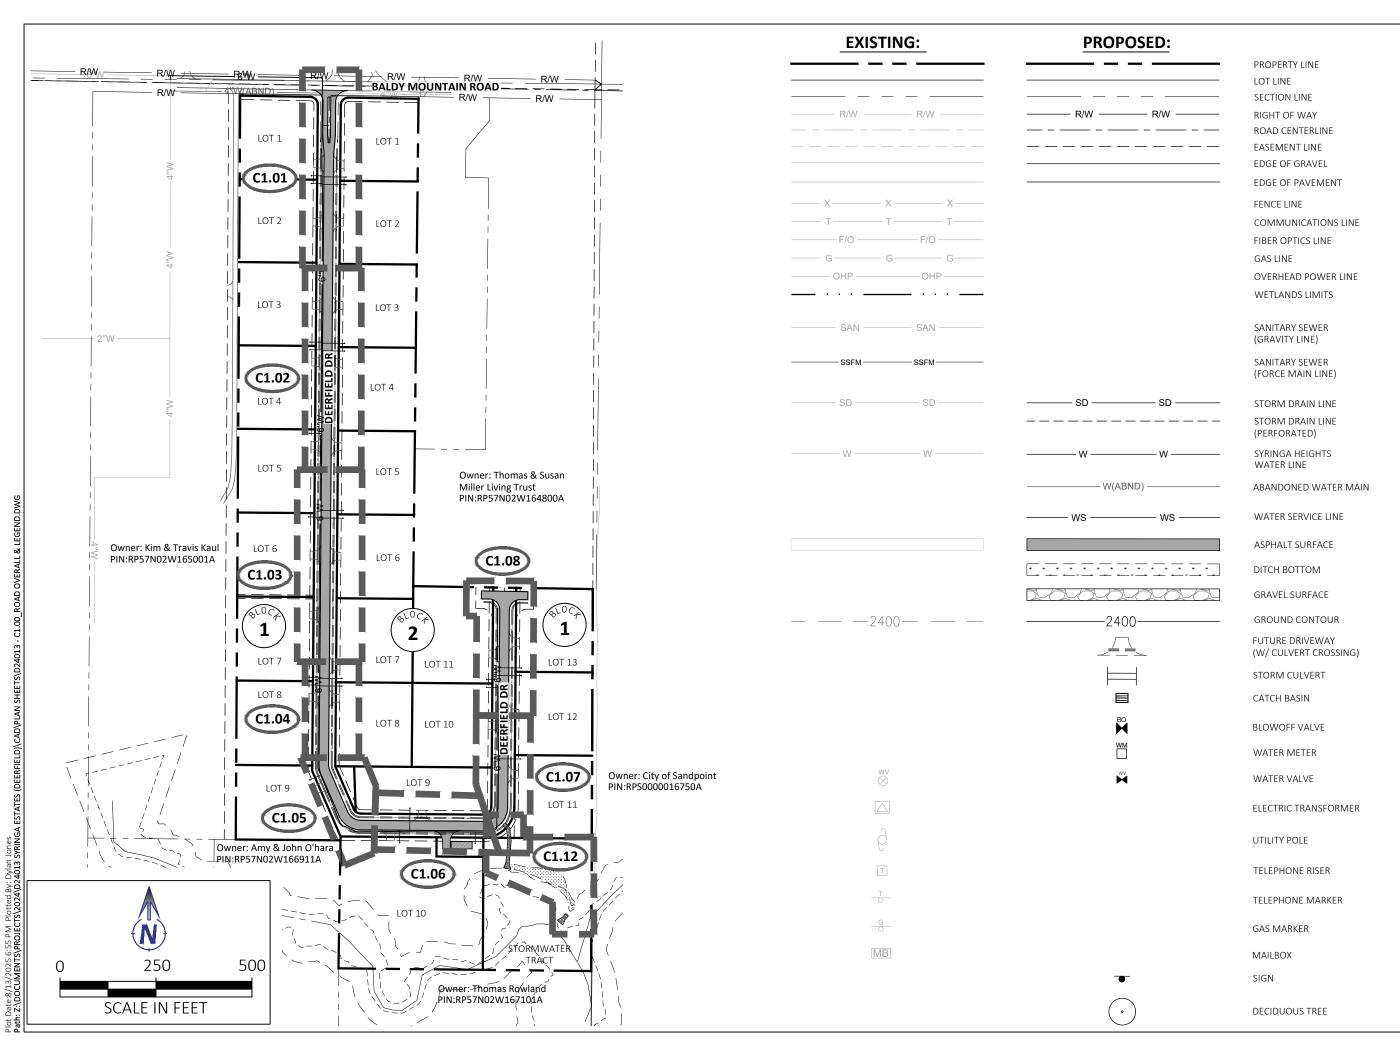

BONNER COUNTY, ID ERFIEL

ROADWAY OVERALL PLAN & LEGEND

iel M. Taa 1803 08/14/202\$ NIEL M. TAD

### CONSTRUCTION **DOCUMENTS**

SCALE: (11X17 ONLY)

DWG:D24013 - C1.00\_ROAD OVERALL & PROJECT NO: D24013

DJJ/DMH DRAWN BY: CHECKED BY: DMT DATF. AUGUST 2025


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REVISIONS

NO. DATE BY DESCRIPTION

**DRAWING:** 

SHEET: 3 OF 20

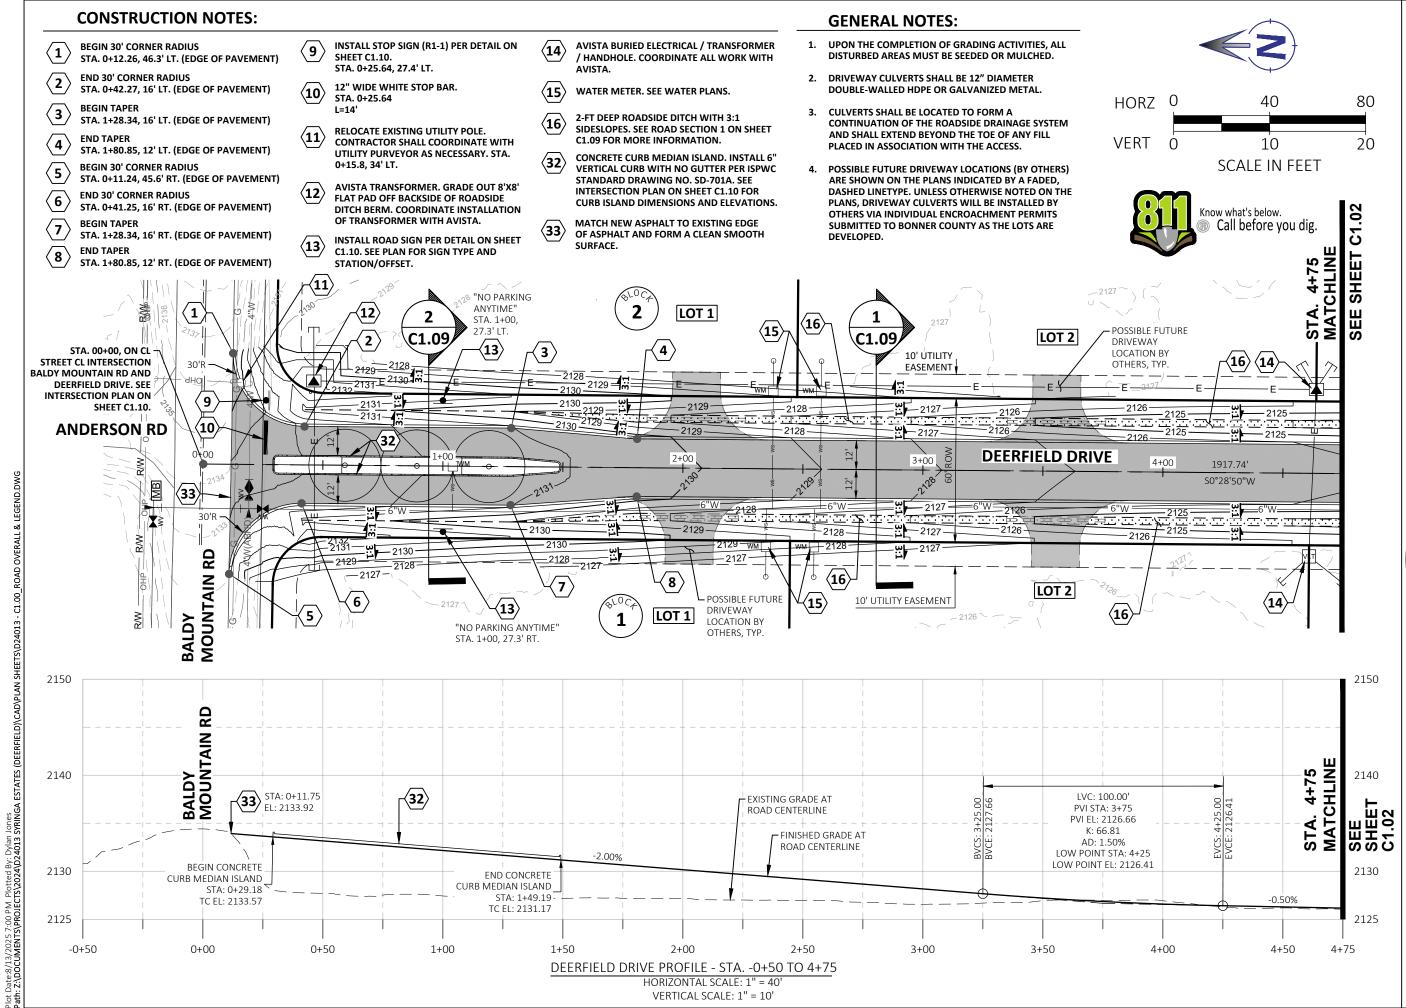

BONNER COUNTY, ID

ERFIE

ROAD PLAN AND PROFILE STA. -0+50 TO STA. 4+75

EESSIONAL EN 1803 OANIEL M. TA

### CONSTRUCTION **DOCUMENTS**

SCALE: (11X17 ONLY)

DWG: D24013 - C1.00 ROAD OVERALL & PROJECT NO: D24013 DRAWN BY: DJJ/DMH CHECKED BY:

DATF.

DMT AUGUST 2025

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NO. DATE BY DESCRIPTION

**DRAWING:** 

SHEET: 4 OF 20

# Know what's below. Call before you dig.

Plot Date:8/13/2025 7:48 PM Plotted By: Dylan Jones Path: 2\,DOCUMENTS\PROJECTS\,2024\D24013 SYRINGA ESTATES (DEERFIELD)\CAD\PLAN SHETS\D24013 - C1.00\_ROAD OVERALL & LEGEND

2110

4+75

5+00

5+50

### **CONSTRUCTION NOTES:**

- **INSTALL ROAD SIGN PER DETAIL ON SHEET** C1.10. SEE PLAN FOR SIGN TYPE AND STATION/OFFSET.
- AVISTA BURIED ELECTRICAL / TRANSFORMER / **14**) HANDHOLE. COORDINATE ALL WORK WITH AVISTA.
- WATER METER. SEE WATER PLANS.
- 2-FT DEEP ROADSIDE DITCH WITH 3:1 **(16)** SIDESLOPES. SEE ROAD SECTION 1 ON SHEET C1.09 FOR MORE INFORMATION.


6+50

6+00

7+00

### **GENERAL NOTES:**

- **UPON THE COMPLETION OF GRADING ACTIVITIES, ALL DISTURBED** AREAS MUST BE SEEDED OR MULCHED.
- DRIVEWAY CULVERTS SHALL BE 12" DIAMETER DOUBLE-WALLED HDPE OR GALVANIZED METAL.
- **CULVERTS SHALL BE LOCATED TO FORM A CONTINUATION OF THE** ROADSIDE DRAINAGE SYSTEM AND SHALL EXTEND BEYOND THE TOE OF ANY FILL PLACED IN ASSOCIATION WITH THE ACCESS.
- POSSIBLE FUTURE DRIVEWAY LOCATIONS (BY OTHERS) ARE SHOWN ON THE PLANS INDICATED BY A FADED, DASHED LINETYPE. UNLESS OTHERWISE NOTED ON THE PLANS, DRIVEWAY CULVERTS WILL BE **INSTALLED BY OTHERS VIA INDIVIDUAL ENCROACHMENT PERMITS**

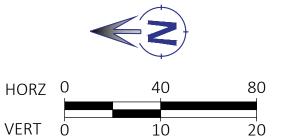

SCALE IN FEET



476864 Highway 95, Suite 3 Ponderay, ID 83852 (208) 635-5825

BONNER COUNTY, ID

ROAD PLAN AND PROFILE STA. 4+75 TO STA. 10+00

DEERFIELD

KESSIONAL ENGI 1803 08/14/2025 DANIEL M. TAD

> CONSTRUCTION **DOCUMENTS**

> > SCALE: (11X17 ONLY)

DWG: D24013 - C1.00\_ROAD OVERALL & PROJECT NO: D24013 DJJ/DMH DRAWN BY:

DATF.

2110

10+00


CHECKED BY: DMT AUGUST 2025

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NO. DATE BY DESCRIPTION

**DRAWING:** 

SHEET: 5 OF 20

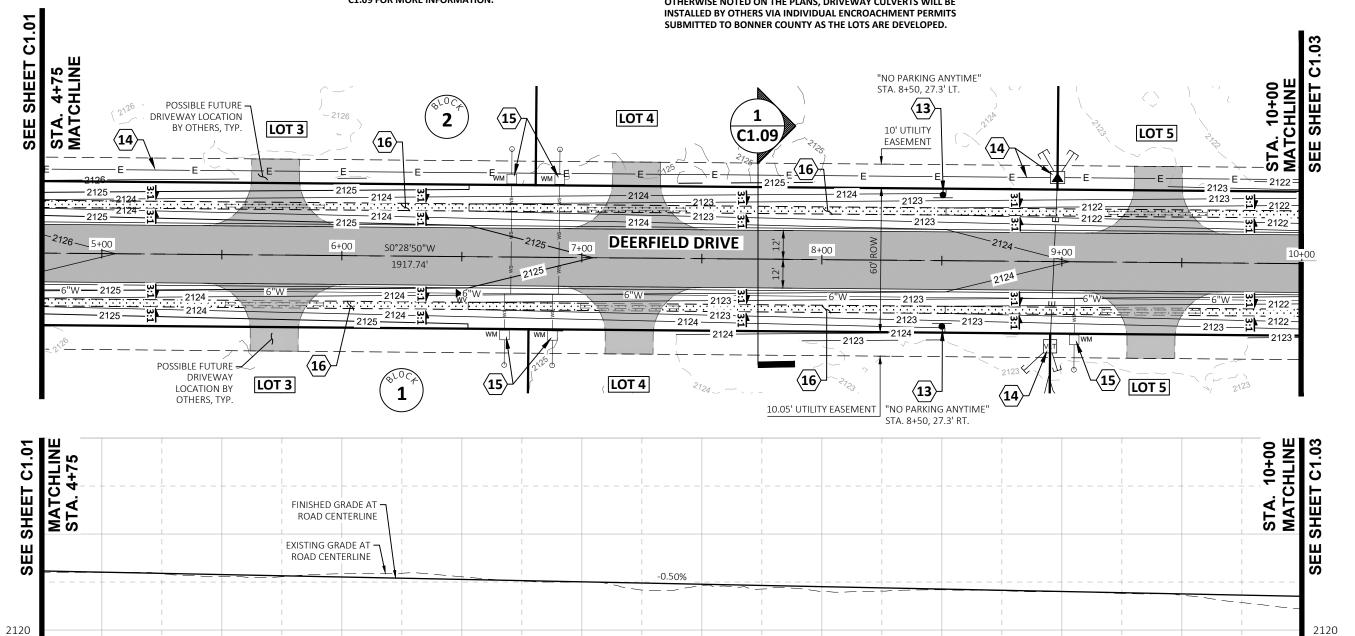

7+50

DEERFIELD DRIVE PROFILE - STA. 4+75 TO 10+00

HORIZONTAL SCALE: 1" = 40 VERTICAL SCALE: 1" = 10'

8+00

8+50

9+00

9+50

# (now what's below. Call before you dig.

10+00

10+50

11+00


11+50


### **CONSTRUCTION NOTES:**

- AVISTA BURIED ELECTRICAL / TRANSFORMER / HANDHOLE. COORDINATE ALL WORK WITH AVISTA.
- WATER METER. SEE WATER PLANS.
- 2-FT DEEP ROADSIDE DITCH WITH 3:1 SIDESLOPES. SEE ROAD SECTION 1 ON SHEET C1.09 FOR MORE INFORMATION.
- STORMWATER CONVEYANCE BASIN. EXCAVATE EXISTING **GROUND MATERIAL AND CREATE STORMWATER BASIN** FOR CONNECTION OF EXISTING SURFACE DRAINAGE
  PATTERN TO NEW ROAD CROSSING CULVERT ELEVATION.

### **GENERAL NOTES:**

- UPON THE COMPLETION OF GRADING ACTIVITIES, ALL DISTURBED AREAS MUST BE SEEDED OR MULCHED.
- DRIVEWAY CULVERTS SHALL BE 12" DIAMETER DOUBLE-WALLED HDPE OR GALVANIZED METAL.
- CULVERTS SHALL BE LOCATED TO FORM A CONTINUATION OF THE ROADSIDE DRAINAGE SYSTEM AND SHALL EXTEND BEYOND THE TOE OF ANY FILL PLACED IN ASSOCIATION WITH THE ACCESS.
- 4. POSSIBLE FUTURE DRIVEWAY LOCATIONS (BY OTHERS) ARE SHOWN ON THE PLANS INDICATED BY A FADED, DASHED LINETYPE. UNLESS OTHERWISE NOTED ON THE PLANS, DRIVEWAY CULVERTS WILL BE INSTALLED BY OTHERS VIA INDIVIDUAL ENCROACHMENT PERMITS SUBMITTED TO BONNER COUNTY

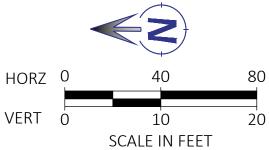


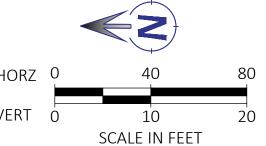



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ROAD PLAN AND PROFILE STA. 10+00 TO STA. 15+00 BONNER COUNTY, ID DEERFIELD



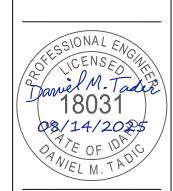

SCALE: (11X17 ONLY)

DWG: D24013 - C1.01 ROAD P&P.DWG PROJECT NO: D24013 DRAWN BY: DJJ/DMH


CHECKED BY: DMT DATF. AUGUST 2025

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NO. DATE BY DESCRIPTION

**DRAWING:** 

SHEET: 6 OF 20

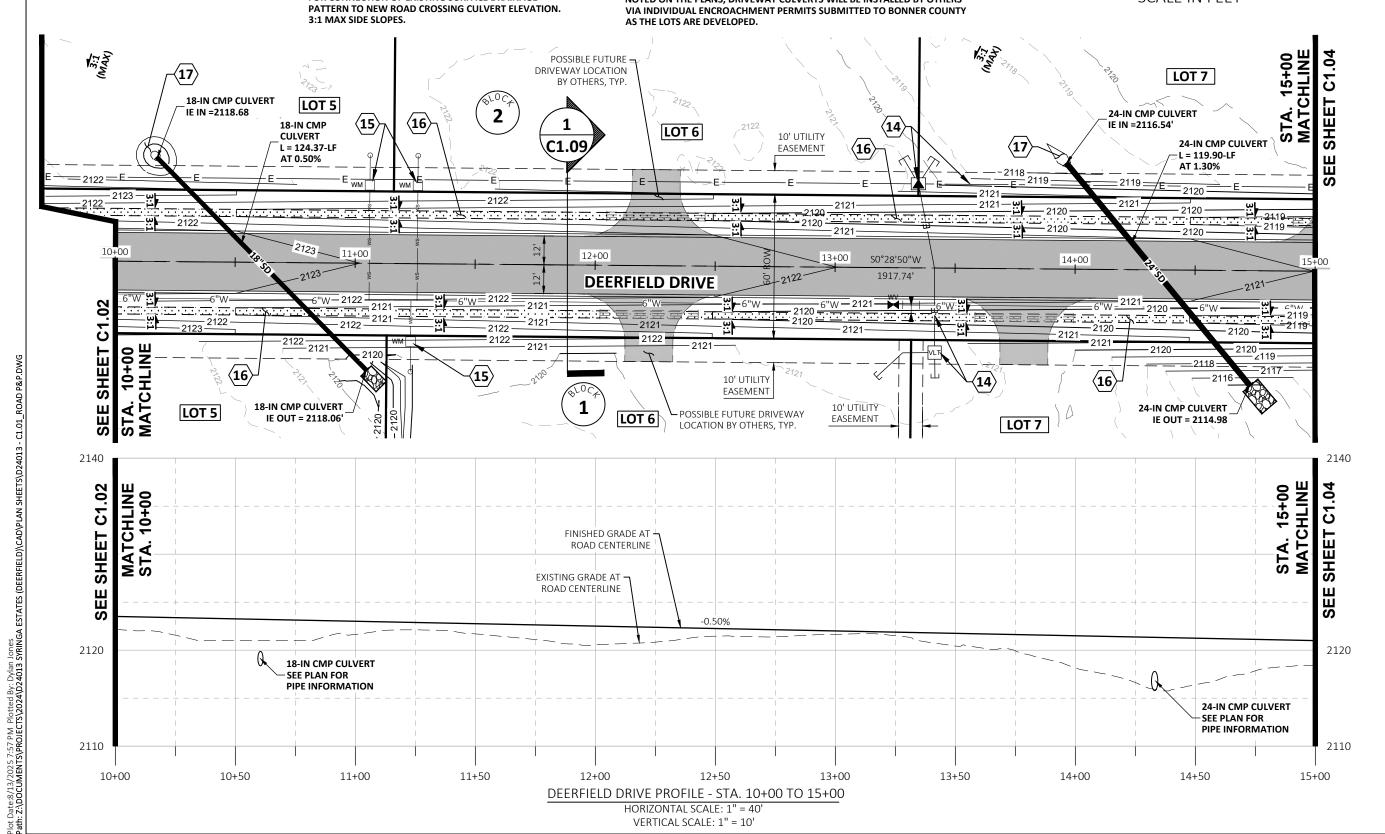

12+50

DEERFIELD DRIVE PROFILE - STA. 10+00 TO 15+00

HORIZONTAL SCALE: 1" = 40' VERTICAL SCALE: 1" = 10'


13+00

13+50

14+00

14+50

15+00

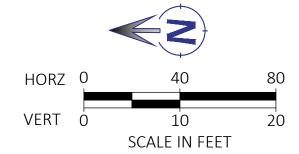

- **INSTALL ROAD SIGN PER DETAIL ON SHEET** C1.10. SEE PLAN FOR SIGN TYPE AND STATION/OFFSET.
- AVISTA BURIED ELECTRICAL / TRANSFORMER / HANDHOLE. COORDINATE ALL WORK WITH AVISTA.
- WATER METER. SEE WATER PLANS.
- 2-FT DEEP ROADSIDE DITCH WITH 3:1 SIDESLOPES. SEE ROAD SECTION 1 ON SHEET C1.09 FOR MORE INFORMATION.
- STORMWATER CONVEYANCE BASIN. EXCAVATE EXISTING GROUND MATERIAL AND CREATE STORMWATER BASIN FOR CONNECTION OF EXISTING SURFACE DRAINAGE PATTERN TO NEW ROAD CROSSING CULVERT ELEVATION. 3:1 MAX SIDE SLOPES.

### **GENERAL NOTES:**

- **UPON THE COMPLETION OF GRADING ACTIVITIES, ALL** DISTURBED AREAS MUST BE SEEDED OR MULCHED.
- DRIVEWAY CULVERTS SHALL BE 12" DIAMETER DOUBLE-WALLED HDPE OR GALVANIZED METAL.
- 3. CULVERTS SHALL BE LOCATED TO FORM A CONTINUATION OF THE ROADSIDE DRAINAGE SYSTEM AND SHALL EXTEND BEYOND THE TOE OF ANY FILL PLACED IN ASSOCIATION WITH
- 4. POSSIBLE FUTURE DRIVEWAY LOCATIONS (BY OTHERS) ARE SHOWN ON THE PLANS INDICATED BY A FADED, DASHED LINETYPE. UNLESS OTHERWISE NOTED ON THE PLANS, DRIVEWAY CULVERTS WILL BE INSTALLED BY OTHERS VIA INDIVIDUAL ENCROACHMENT PERMITS SUBMITTED TO BONNER COUNTY AS THE LOTS ARE DEVELOPED.



476864 Highway 95, Suite 3 Ponderay, ID 83852 (208) 635-5825

ROAD PLAN AND PROFILE STA. 15+00 TO STA. 17+50 BONNER COUNTY, ID DEERFIELD



### CONSTRUCTION **DOCUMENTS**

SCALE: (11X17 ONLY)

DWG: D24013 - C1.01 ROAD P&P.DWG PROJECT NO: D24013 DRAWN BY: DJJ/DMH

CHECKED BY: DMT DATF. AUGUST 2025

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NO. DATE BY DESCRIPTION

**DRAWING:** 

SHEET: 7 OF 20

Plot Date:8/13/2025 8:06 PM Plotted By: Dylan Jones Path: 2:\DOCUMENTS\PROJECTS\2024\D24013 SYRINGA ESTATES (DEERFIELD)\CAD\PLAN SHEETS\D24013 -

15+00

15+50


DEERFIELD DRIVE PROFILE - STA. 15+00 TO 17+50 HORIZONTAL SCALE: 1" = 40 VERTICAL SCALE: 1" = 10'


16+00

16+50

17+00

17+50

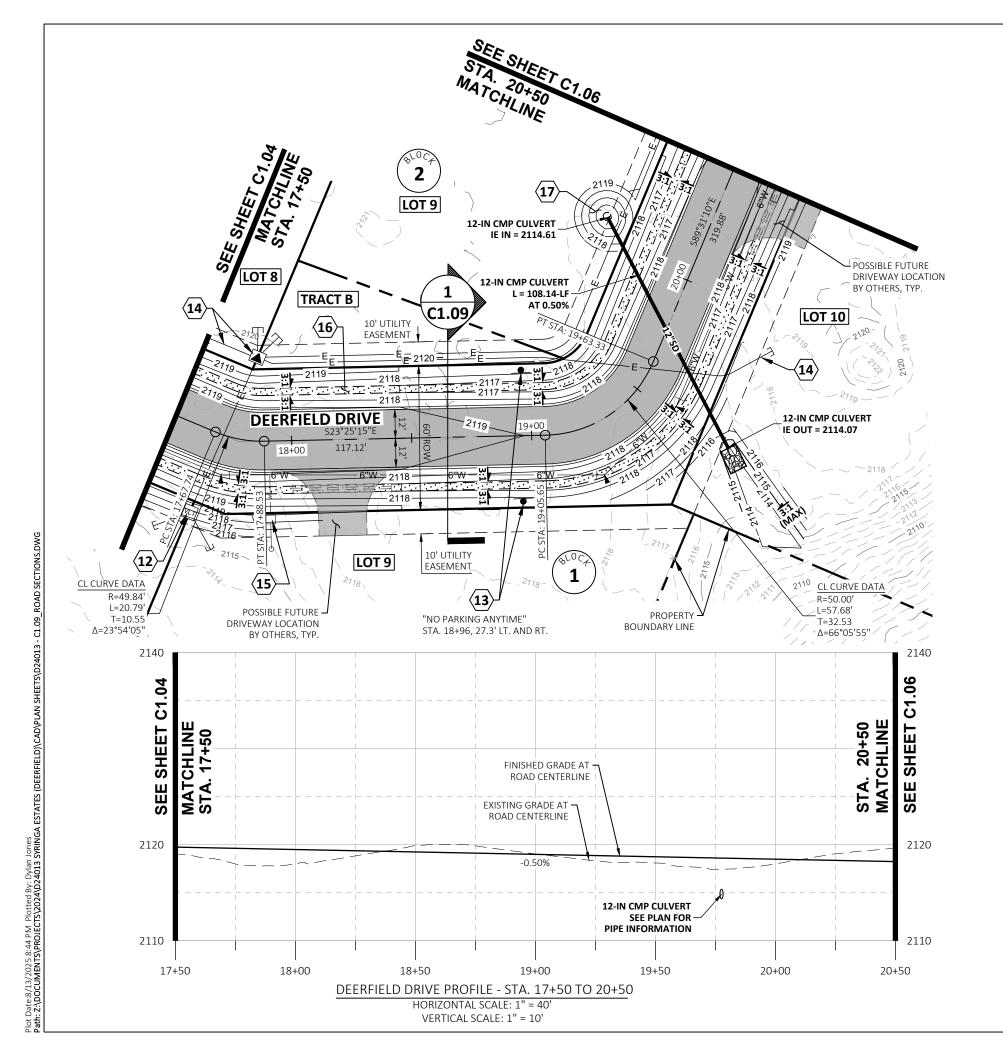

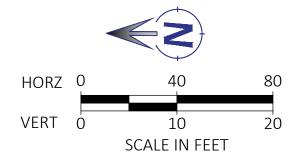

- AVISTA TRANSFORMER. GRADE OUT 8'X8' FLAT PAD OFF BACKSIDE OF ROADSIDE DITCH BERM. COORDINATE INSTALLATION OF TRANSFORMER WITH AVISTA.
  - install road sign per detail on sheet C1.10. See Plan for sign type and station/offset.
- AVISTA BURIED ELECTRICAL / TRANSFORMER / HANDHOLE. COORDINATE ALL WORK WITH AVISTA.
- 15 WATER METER. SEE WATER PLANS.
- 2-FT DEEP ROADSIDE DITCH WITH 3:1
  SIDESLOPES. SEE ROAD SECTION 1 ON SHEET
  C1.09 FOR MORE INFORMATION.
- STORMWATER CONVEYANCE BASIN. EXCAVATE EXISTING GROUND MATERIAL AND CREATE STORMWATER BASIN FOR CONNECTION OF EXISTING SURFACE DRAINAGE PATTERN TO NEW ROAD CROSSING CULVERT ELEVATION. 3:1 MAX SIDE SLOPES.


### **GENERAL NOTES:**

- UPON THE COMPLETION OF GRADING ACTIVITIES, ALL DISTURBED AREAS MUST BE SEEDED OR MULCHED.
- DRIVEWAY CULVERTS SHALL BE 12" DIAMETER DOUBLE-WALLED HDPE OR GALVANIZED METAL.
- 3. CULVERTS SHALL BE LOCATED TO FORM A CONTINUATION OF THE ROADSIDE DRAINAGE SYSTEM AND SHALL EXTEND BEYOND THE TOE OF ANY FILL PLACED IN ASSOCIATION WITH THE ACCESS.
- 4. POSSIBLE FUTURE DRIVEWAY LOCATIONS (BY OTHERS) ARE SHOWN ON THE PLANS INDICATED BY A FADED, DASHED LINETYPE. UNLESS OTHERWISE NOTED ON THE PLANS, DRIVEWAY CULVERTS WILL BE INSTALLED BY OTHERS VIA INDIVIDUAL ENCROACHMENT PERMITS SUBMITTED TO BONNER COUNTY AS THE LOTS ARE DEVELOPED.



476864 Highway 95, Suite 3 Ponderay, ID 83852 (208) 635-5825

DEERFIELD
BONNER COUNTY, ID
ROAD PLAN AND PROFILE
STA. 17+50 TO STA. 20+50

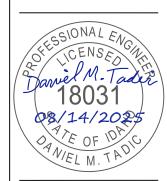

## CONSTRUCTION DOCUMENTS

1" SCALE: (11X17 ONLY)

DWG: D24013 - C1.09\_ROAD SECTIONS.DWG
PROJECT NO: D24013

DRAWN BY: DJJ/DMH
CHECKED BY: DMT
DATE: AUGUST 2025

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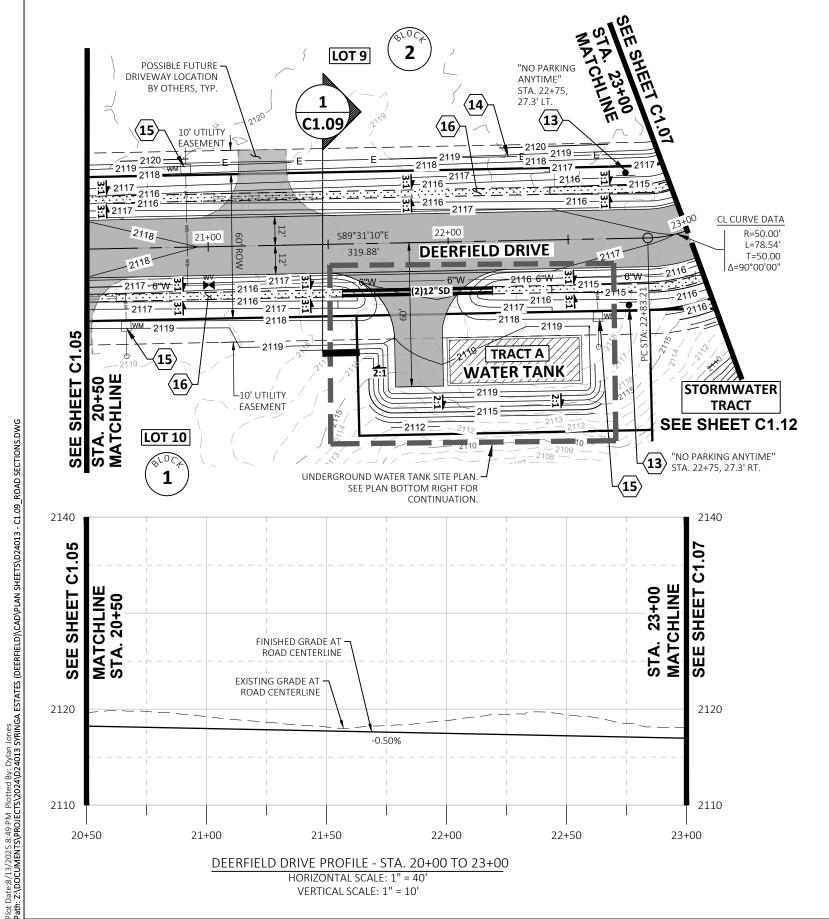
REVISIONS

NO. DATE BY DESCRIPTION

C1.05

**DRAWING:** 

SHEET: 8 OF 20




HORIZONTAL SCALE: 1" = 40

VERTICAL SCALE: 1" = 10'

### **CONSTRUCTION NOTES:**

- **INSTALL ROAD SIGN PER DETAIL ON SHEET C1.10.** SEE PLAN FOR SIGN TYPE AND STATION/OFFSET.
- AVISTA BURIED ELECTRICAL / TRANSFORMER / HANDHOLE. COORDINATE ALL WORK WITH AVISTA.
- WATER METER. SEE WATER PLANS.
- 2-FT DEEP ROADSIDE DITCH WITH 3:1 SIDESLOPES. SEE ROAD SECTION 1 ON SHEET C1.09 FOR MORE INFORMATION.
- **BEGIN 28' CORNER RADIUS** STA. 21+49.30, 12' RT. (EDGE OF PAVEMENT) FG EL. 2117.49
- **END 28' CORNER RADIUS** STA. 21+76.88, 39.5' RT. (EDGE OF PAVEMENT) FG EL. 2119.00
- END PAVEMENT STA. 21+76.88, 60' RT. (EDGE OF PAVEMENT) FG EL. 2119.25
- **END PAVEMENT** STA. 21+96.88, 60' RT. (EDGE OF PAVEMENT) FG EL. 2119.25
- **BEGIN 28' CORNER RADIUS** STA. 21+96.88, 36' RT. (EDGE OF PAVEMENT) FG EL. 2118.59
- **END 28' CORNER RADIUS** STA. 22+24.00, 12' RT. (EDGE OF PAVEMENT) FG EL. 2117.11
- **TANDEM 12" CMP CULVERTS** 62.5 LF AT 0.5% IE (IN): 2115.40 (W) IE (OUT): 2115.09 (E)



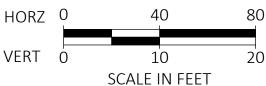

### **GENERAL NOTES:**

- UPON THE COMPLETION OF GRADING ACTIVITIES, ALL DISTURBED AREAS MUST BE SEEDED OR MULCHED.
- **DRIVEWAY CULVERTS SHALL BE 12" DIAMETER** DOUBLE-WALLED HDPE OR GALVANIZED METAL.
- **CULVERTS SHALL BE LOCATED TO FORM A** CONTINUATION OF THE ROADSIDE DRAINAGE SYSTEM AND SHALL EXTEND BEYOND THE TOE OF ANY FILL PLACED IN ASSOCIATION WITH THE ACCESS.
- POSSIBLE FUTURE DRIVEWAY LOCATIONS (BY OTHERS) ARE SHOWN ON THE PLANS INDICATED BY A FADED, DASHED LINETYPE. UNLESS OTHERWISE NOTED ON THE PLANS, DRIVEWAY CULVERTS WILL BE INSTALLED BY OTHERS VIA INDIVIDUAL ENCROACHMENT PERMITS SUBMITTED TO BONNER COUNTY AS THE LOTS ARE DEVELOPED.

**DEERFIELD DRIVE** 22+00 = 2117 = - 2117 -**2118** TRACT A WATER TANK

> UNDERGROUND WATER TANK SITE PLAN HORIZONTAL SCALE: 1" = 40'



476864 Highway 95, Suite 3 Ponderay, ID 83852 (208) 635-5825

ROAD PLAN AND PROFILE STA. 20+50 TO STA. 23+00 BONNER COUNTY, ID ERFIE

ESSIONAL EN

### CONSTRUCTION **DOCUMENTS**

SCALE: (11X17 ONLY)

DWG: D24013 - C1.09 ROAD SECTIONS.DWG PROJECT NO: D24013 DJJ/DMH DRAWN BY:


CHECKED BY: DMT DATF. AUGUST 2025


> © 2025 | ALL RIGHTS RESERVED REVISIONS


NO. DATE BY DESCRIPTION

**DRAWING:** 

SHEET: 9 OF 20

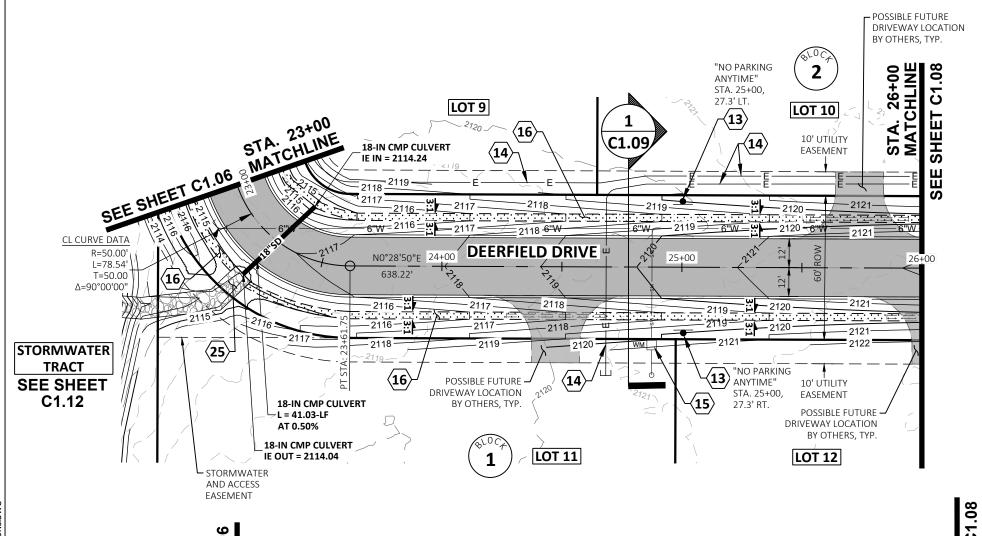

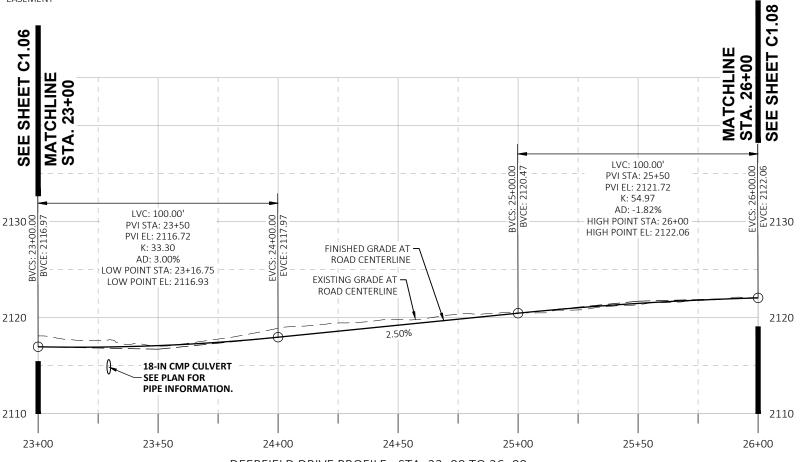

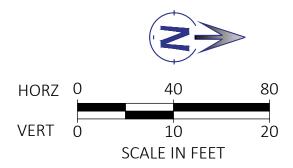

- **INSTALL ROAD SIGN PER DETAIL ON SHEET C1.10. SEE PLAN** FOR SIGN TYPE AND STATION/OFFSET.
- AVISTA BURIED ELECTRICAL / TRANSFORMER / HANDHOLE. COORDINATE ALL WORK WITH AVISTA.
- WATER METER. SEE WATER PLANS.
- 2-FT DEEP ROADSIDE DITCH WITH 3:1 SIDESLOPES. SEE ROAD SECTION 1 ON SHEET C1.09 FOR MORE INFORMATION.
- 1-FT DEEP X 9-FT WIDE RIP RAP LINED CHANNEL WITH 3:1 SIDE SLOPES PER DETAIL ON SHEET C1.11.


### **GENERAL NOTES:**

- **UPON THE COMPLETION OF GRADING ACTIVITIES, ALL** DISTURBED AREAS MUST BE SEEDED OR MULCHED.
- **DRIVEWAY CULVERTS SHALL BE 12" DIAMETER** DOUBLE-WALLED HDPE OR GALVANIZED METAL.
- **CULVERTS SHALL BE LOCATED TO FORM A CONTINUATION** OF THE ROADSIDE DRAINAGE SYSTEM AND SHALL EXTEND BEYOND THE TOE OF ANY FILL PLACED IN ASSOCIATION WITH
- 4. POSSIBLE FUTURE DRIVEWAY LOCATIONS (BY OTHERS) ARE SHOWN ON THE PLANS INDICATED BY A FADED, DASHED LINETYPE. UNLESS OTHERWISE NOTED ON THE PLANS, DRIVEWAY CULVERTS WILL BE INSTALLED BY OTHERS VIA INDIVIDUAL ENCROACHMENT PERMITS SUBMITTED TO BONNER COUNTY AS THE LOTS ARE DEVELOPED.



476864 Highway 95, Suite 3 Ponderay, ID 83852 (208) 635-5825

ROAD PLAN AND PROFILE STA. 23+00 TO STA. 26+00 BONNER COUNTY, ID DEERFIELD

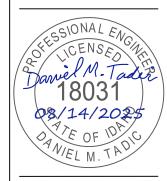

### CONSTRUCTION **DOCUMENTS**

SCALE: (11X17 ONLY)

DWG: D24013 - C1.09 ROAD SECTIONS.DWG PROJECT NO: D24013 DJJ/DMH DRAWN BY:


CHECKED BY: DMT DATF. AUGUST 2025

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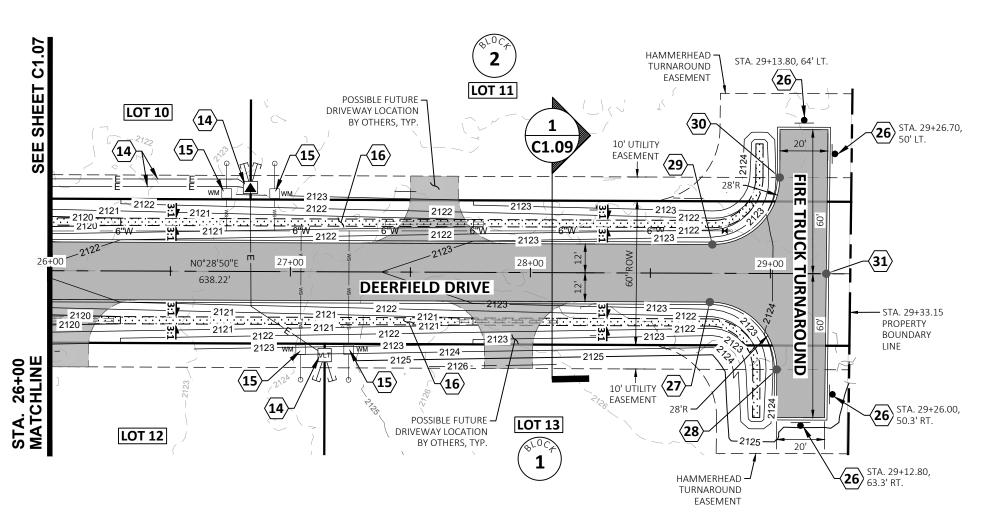
NO. DATE BY DESCRIPTION


**DRAWING:** 


SHEET: 10 OF 20

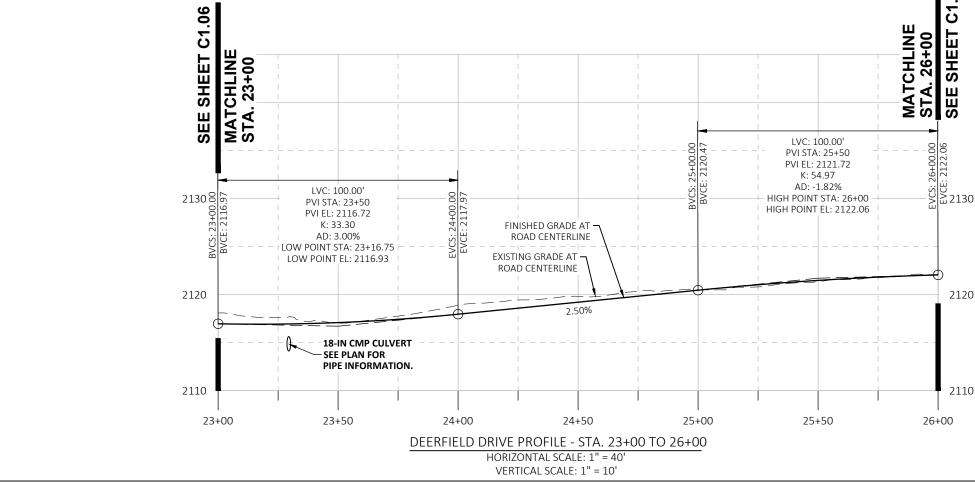

Date:8/13/2025 8:54 PM Plotted By: Dylan Jones n: Z\DoCUMENTS\PROJECTS\2024\D24013 SYRINGA ESTATES (DEERHELD)\CAD\PLAN



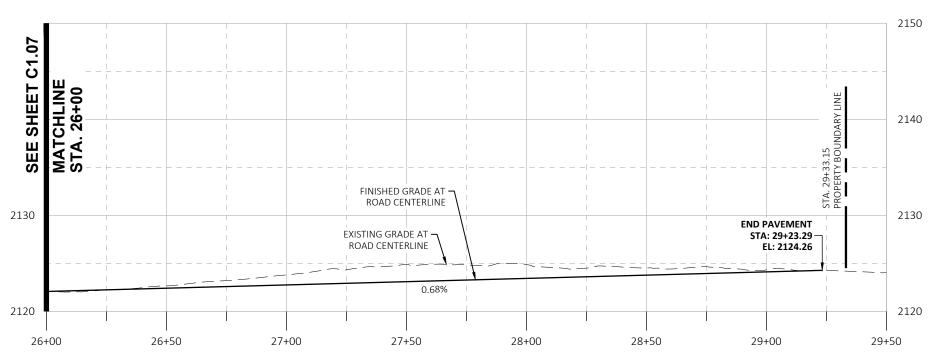

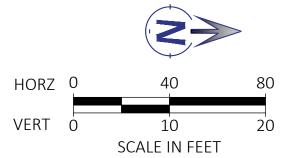

- AVISTA BURIED ELECTRICAL / TRANSFORMER / HANDHOLE. COORDINATE ALL WORK WITH AVISTA.
- WATER METER. SEE WATER PLANS.
- 2-FT DEEP ROADSIDE DITCH WITH 3:1 (16) SIDESLOPES. SEE ROAD SECTION 1 ON SHEET C1.09 FOR MORE INFORMATION.
- "NO PARKING FIRE LANE" SIGN PER DETAIL ON SHEET C1.10. SEE PLAN FOR STATION AND OFFSET.
- **BEGIN 28' CORNER RADIUS** STA. 28+74.80, 12' RT. (EDGE OF PAVEMENT)
- **END 28' CORNER RADIUS** STA. 29+02.80, 40' RT. (EDGE OF PAVEMENT)
- **BEGIN 28' CORNER RADIUS** STA. 28+75.77, 12' LT. (EDGE OF PAVEMENT)
- **END 28' CORNER RADIUS** STA. 29+03.77, 40' LT. (EDGE OF PAVEMENT)
- STA. 29+23.28, ON CL (EDGE OF PAVEMENT)

### **GENERAL NOTES:**


- **UPON THE COMPLETION OF GRADING ACTIVITIES, ALL** DISTURBED AREAS MUST BE SEEDED OR MULCHED.
- 2. DRIVEWAY CULVERTS SHALL BE 12" DIAMETER DOUBLE-WALLED HDPE OR GALVANIZED METAL.
- 3. CULVERTS SHALL BE LOCATED TO FORM A CONTINUATION OF THE ROADSIDE DRAINAGE SYSTEM AND SHALL EXTEND BEYOND THE TOE OF ANY FILL PLACED IN ASSOCIATION WITH
- 4. POSSIBLE FUTURE DRIVEWAY LOCATIONS (BY OTHERS) ARE SHOWN ON THE PLANS INDICATED BY A FADED, DASHED LINETYPE. UNLESS OTHERWISE NOTED ON THE PLANS, DRIVEWAY CULVERTS WILL BE INSTALLED BY OTHERS VIA INDIVIDUAL ENCROACHMENT PERMITS SUBMITTED TO BONNER COUNTY AS THE LOTS ARE DEVELOPED.



476864 Highway 95, Suite 3 Ponderay, ID 83852 (208) 635-5825

ROAD PLAN AND PROFILE BONNER COUNTY, ID ERFIELD

STA. 26+00 TO STA.

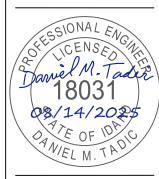

### CONSTRUCTION **DOCUMENTS**

SCALE: (11X17 ONLY)

DWG: D24013 - C1.09 ROAD SECTIONS.DWG PROJECT NO: D24013

DJJ/DMH DRAWN BY: CHECKED BY: DMT DATF. AUGUST 2025


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REVISIONS

NO. DATE BY DESCRIPTION


**DRAWING:** 

SHEET: 11 OF 20

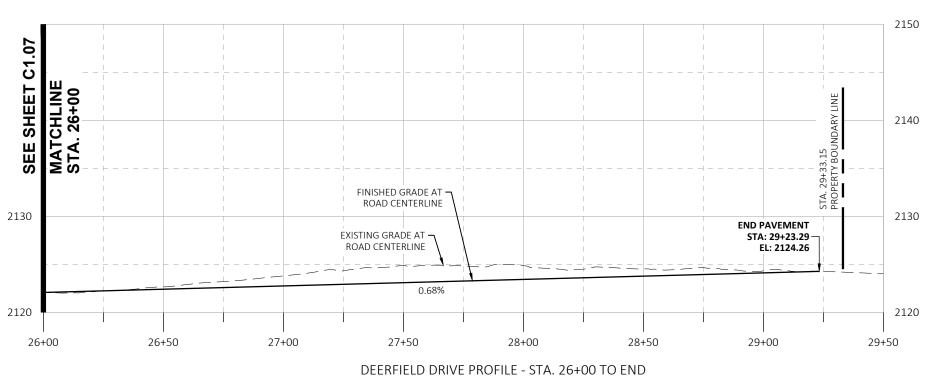

HORIZONTAL SCALE: 1" = 40 VERTICAL SCALE: 1" = 10'

Plot Date:8/13/2025 9:00 PM Plotted By: Dylan Jones Path: Z:\DOCUMENTS\PROJECTS\2024\D24013 SYRINGA ESTATES (DEERFIELD)\CAD\PI

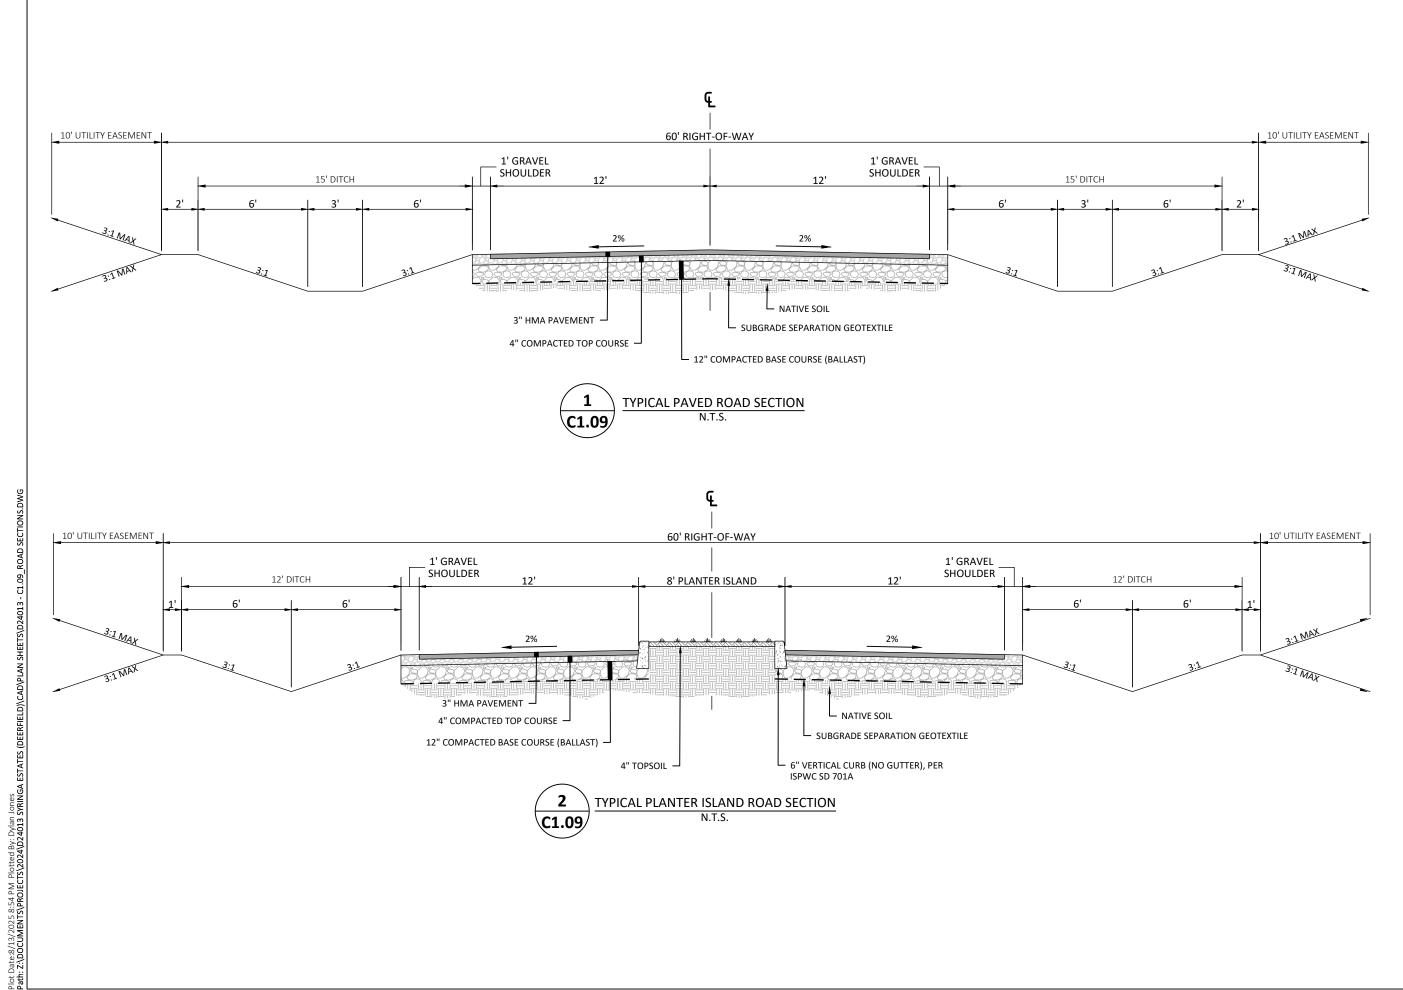

L NATIVE SOIL

6" VERTICAL CURB (NO GUTTER), PER ISPWC SD 701A

SUBGRADE SEPARATION GEOTEXTILE

3" HMA PAVEMENT

4" COMPACTED TOP COURSE

12" COMPACTED BASE COURSE (BALLAST) —

4" TOPSOIL


TYPICAL PLANTER ISLAND ROAD SECTION

N.T.S.

476864 Highway 95, Suite 3 Ponderay, ID 83852 (208) 635-5825

BONNER COUNTY, ID DEERFIELD

**ROAD SECTIONS** 

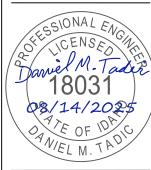

### **CONSTRUCTION DOCUMENTS**

SCALE: (11X17 ONLY)

DWG: D24013 - C1.09\_ROAD SECTIONS.DWG PROJECT NO: D24013 DJJ/DMH DRAWN BY: CHECKED BY: DMT DATE: AUGUST 2025

3:1 MAX

REVISIONS

NO. DATE BY DESCRIPTION

DRAWING:

SHEET: 12 OF 20

- **INSTALL STOP SIGN (R1-1)** PER DETAIL THIS SHEET. STA. 0+25.64, 27.4' LT.
- 12" WIDE WHITE STOP BAR. STA. 0+25.64 L=14'
- CONCRETE CURB MEDIAN ISLAND. INSTALL 6" VERTICAL CURB WITH NO GUTTER PER ISPWC STANDARD DRAWING NO. SD-701A.
- MATCH NEW ASPHALT TO EXISTING EDGE OF ASPHALT AND FORM A **CLEAN SMOOTH SURFACE.**

L=47.37' T=30.25 <del>ί</del> Δ=90°28'21"

2130

2131-

-2132

**-(32**)

**32** 

-2131

2130


<del>-</del> 2131-

- 2131-

L=46.92'

T=29.80 Δ=89°36'57"

- 2132 -

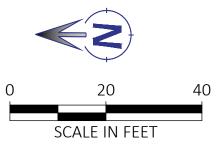

FG: 2131.02

FG: 2131.26

FG: 2131.77

FG: 2131.77

FG: 2131.27

FG: 2131.00-

2131

-FG: 2131.25

-FG: 2131.75

~FG: 2131.75

FG: 2131.25

2130 -

- 2131-

2131

FG: 2131.88

FG: 2132.50

FG: 2132.12

∕FG: 2131.89

**DEERFIELD DRIVE** 

- 2130 ·

- 2130 -

- 2131-

- 2131-

S0°28'50"W

1917.74'

-2128 -

- 2129 -

- 2130 -

- 2130 -

FG: 2130.76

►FG: 2131.54

FG: 2131.68

FG: 2131.68

- 2130 -

- 2129

FG: 2131.18

FG: 2130.76

 $=_{21\overline{27}}$ 






**NO PARKING - FIRE LINE** 

NOT TO SCALE



**NO PARKING - ANY TIME SIGN DETAIL** 

NOT TO SCALE

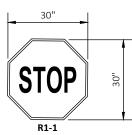

NOT TO SCALE

R7-1

**SIGN DETAIL** 

Plot Date:8/13/2025 8:59 PM Plotted By: Dylan Jones Path: 2:\DOCUMENTS\PROJECTS\2024\D24013 SYRINGA ESTATES (DEERFIELD)\CAD\PLAN SHEETS\D24013 - C1.10\_ROAD DETAILS. Know what's below. Call before you dig.

**MOUNTAIN ROAD** 

BALDY

-2133\_

FG: 2134.43

FG: 2133.55

FG: 2133.57

FG: 2133.92

**-**⟨33⟩

FG: 2132.36~

FG: 2132.5

-2130 ti

-2129

FG: 2132.74

FG: 2132.76 -

FG: 2133.20

~FG: 2133.70 i


FG: 2133.70

FG: 2133.20

INTERSECTION DETAIL - BALDY MOUNTAIN ROAD AND DEERFIELD DRIVE HORIZONTAL SCALE: 1" = 20'

476864 Highway 95, Suite 3 Ponderay, ID 83852 (208) 635-5825

BONNER COUNTY, ID INTERSECTION PLAN AND ROAD DETAILS DEERFIELD

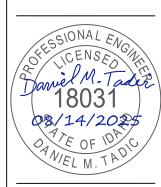

### CONSTRUCTION **DOCUMENTS**

SCALE: (11X17 ONLY)

DWG: D24013 - C1.10 ROAD DETAILS.DWG PROJECT NO: D24013 DJJ/DMH DRAWN BY:


CHECKED BY: DMT DATE: AUGUST 2025

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NO. DATE BY DESCRIPTION

**DRAWING:** 

SHEET: 13 OF 20

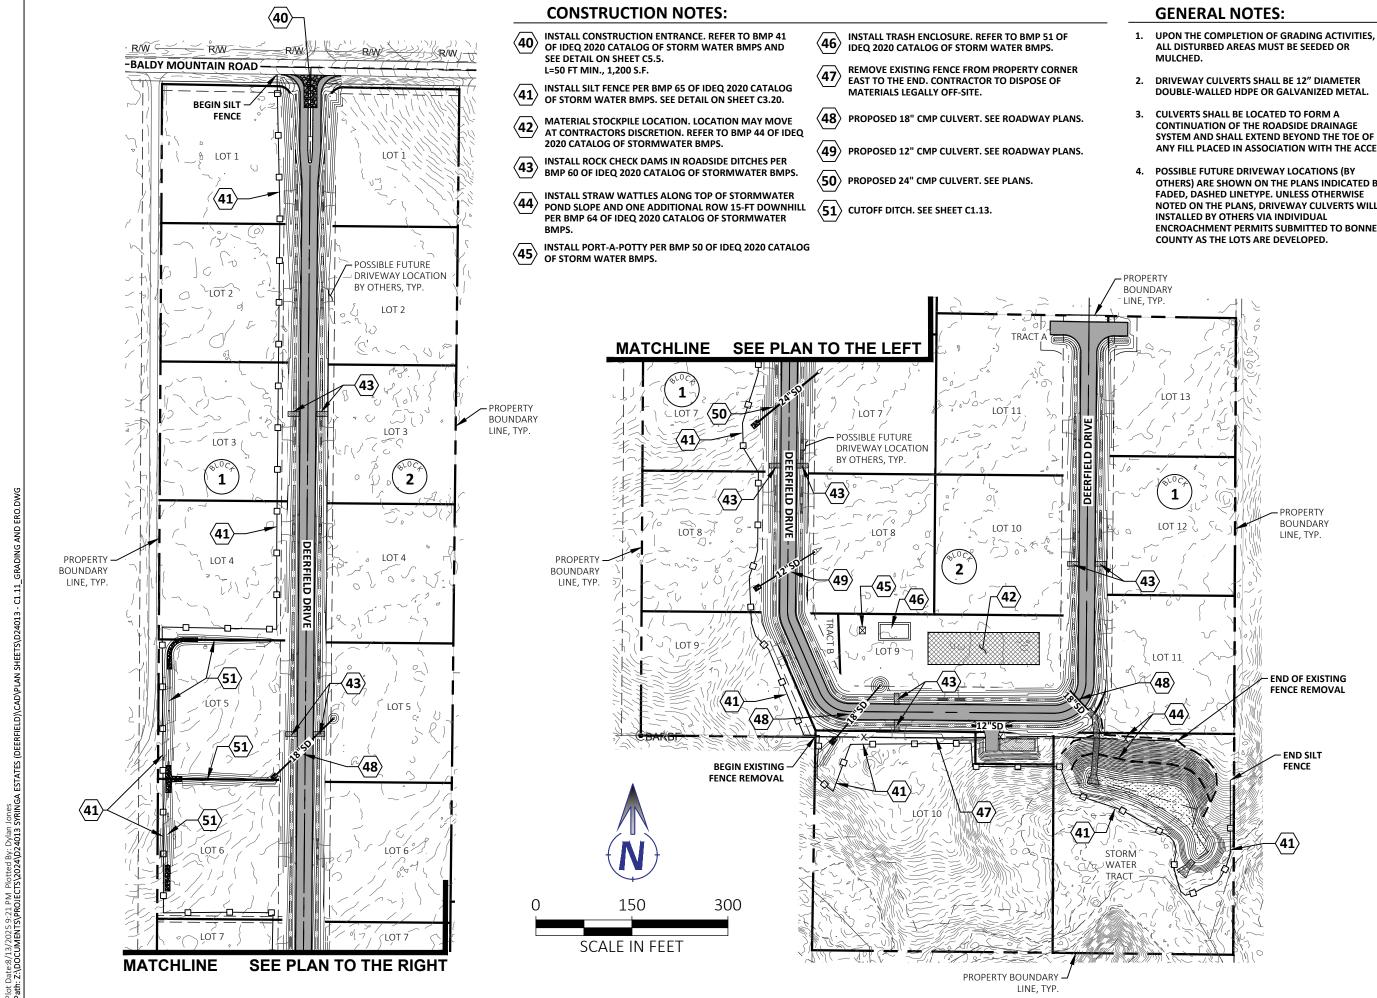

DOUBLE-WALLED HDPE OR GALVANIZED METAL.


SYSTEM AND SHALL EXTEND BEYOND THE TOE OF ANY FILL PLACED IN ASSOCIATION WITH THE ACCESS.

OTHERS) ARE SHOWN ON THE PLANS INDICATED BY A NOTED ON THE PLANS, DRIVEWAY CULVERTS WILL BE **ENCROACHMENT PERMITS SUBMITTED TO BONNER** 

476864 Highway 95, Suite 3 Ponderay, ID 83852 (208) 635-5825

> SEDIMENT CONTROL PLAN COUNTY, ID BONNER OVERALL

EERFIE

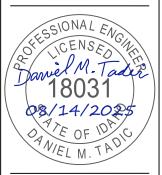

### CONSTRUCTION **DOCUMENTS**

SCALE: (11X17 ONLY)

DWG: D24013 - C1.11\_GRADING AND ERO.DWG

PROJECT NO: D24013

DJJ/DMH DRAWN BY: CHECKED BY: DMT

DATF.


AUGUST 2025

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NO. DATE BY DESCRIPTION

**DRAWING:** 

SHEET: 14 OF 20

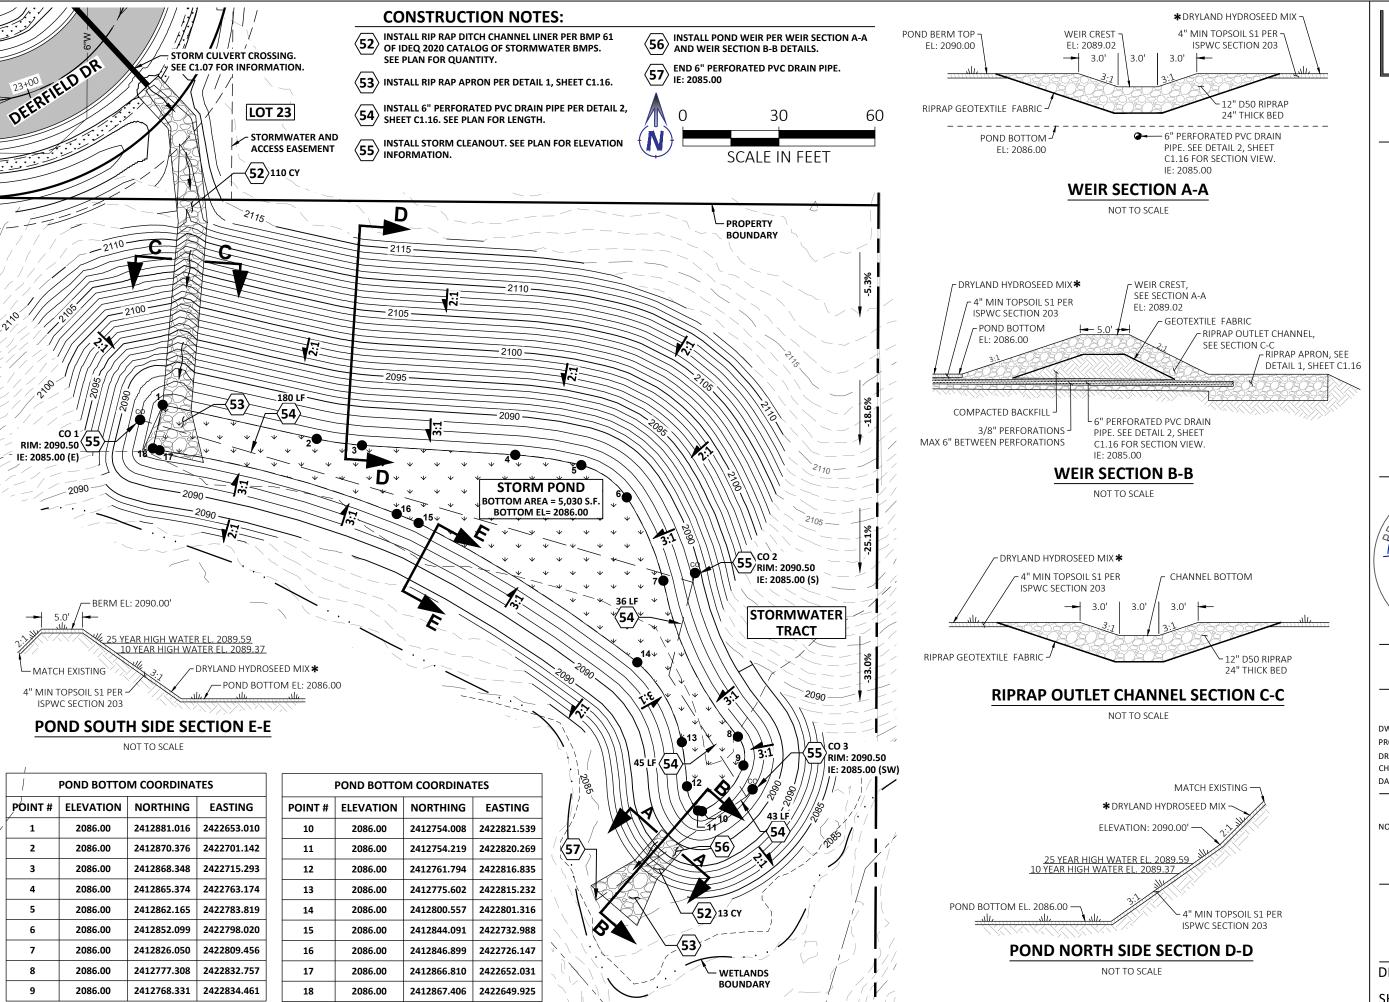

**DETAILED GRADING PLAN** COUNTY, ID STORMWATER POND BONNER

1803 08/14/2025

### CONSTRUCTION **DOCUMENTS**

SCALE: (11X17 ONLY)

DWG: D24013 - C1.12 STORM POND.DWG PROJECT NO: D24013

DRAWN BY: DJJ/DMH CHECKED BY: DATF.


DMT AUGUST 2025 © 2025 | ALL RIGHTS RESERVED


REVISIONS

NO. DATE BY DESCRIPTION


**DRAWING:** 

SHEET: 15 OF 20

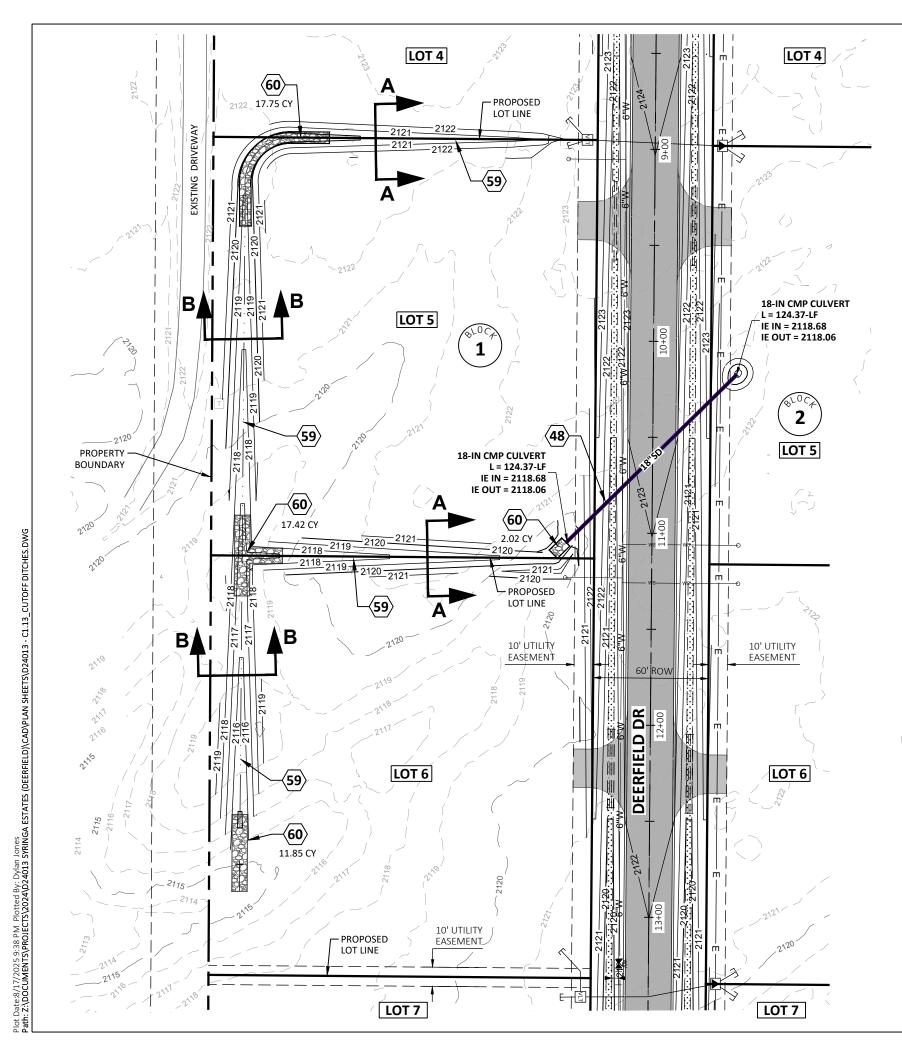

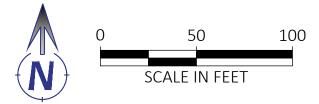


- PROPOSED 18" CMP CULVERT. SEE PLAN FOR MORE INFORMATION.
- PROPOSED 2' MIN. DEPTH FLAT BOTTOM CUTOFF DITCH WITH 3:1 SIDESLOPES. SEE PLAN.
- (60) INSTALL 6" D50 RIP RAP PAD. SEE PLAN FOR QUANTITY.

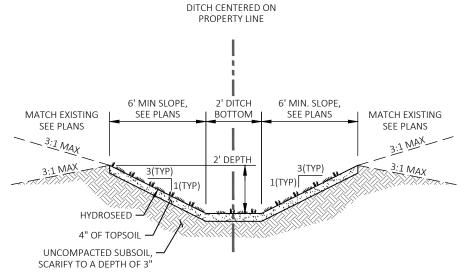

### **DITCH SECTION A-A**

NOT TO SCALE

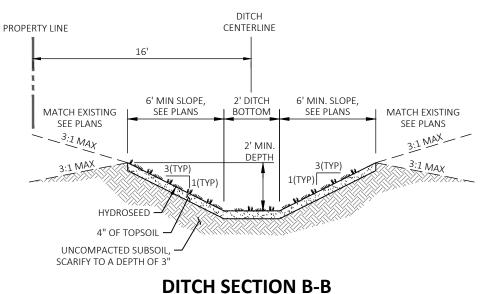


NOT TO SCALE

engineering
476864 Highway 95, Suite 3

476864 Highway 95, Suite Ponderay, ID 83852 (208) 635-5825

DEERFIELD
BONNER COUNTY, ID
LOTS 5 AND 6
DETAILED GRADING
PLAN

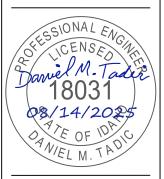

# CONSTRUCTION DOCUMENTS

1" SCALE: (11X17 ONLY)

DWG: D24013 - C1.13\_CUTOFF DITCHES.DWG
PROJECT NO: D24013

DRAWN BY: DJJ/DMH
CHECKED BY: DMT
DATE: AUGUST 2025

E: AUGUST 202

REVISIONS

NO. DATE BY DESCRIPTION

C1.13

**DRAWING:** 

SHEET: 16 OF 20

BONNER COUNTY, ID DEERFIELD

WATER TANK SITE CROSS SECTION

### **CONSTRUCTION DOCUMENTS**

SCALE: (11X17 ONLY)

DWG: D24013 - C1.14\_TANK SITE SECTION.DWG PROJECT NO: D24013 DRAWN BY: DJJ/DMH

CHECKED BY: DMT DATE: AUGUST 2025

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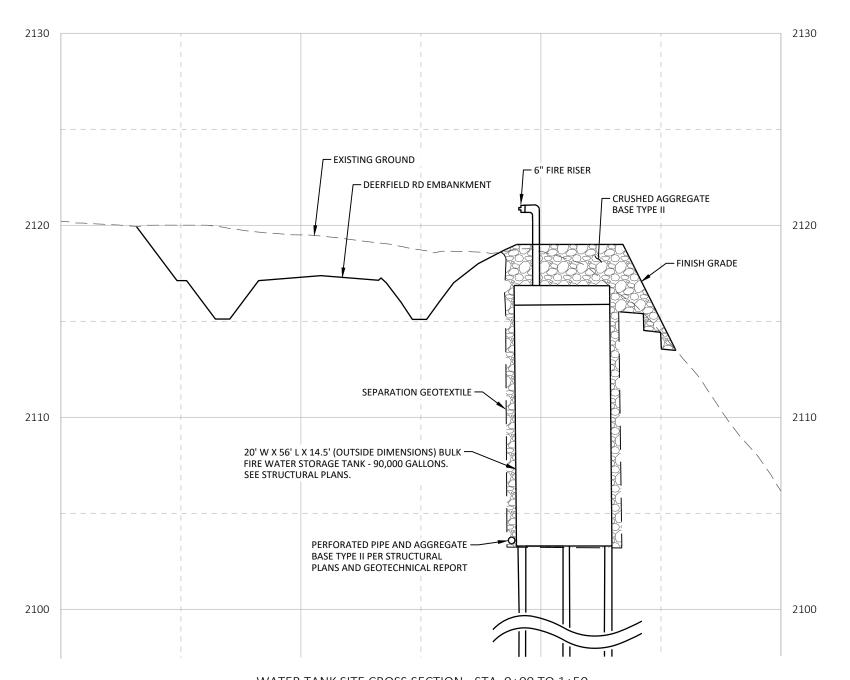
NO. DATE BY DESCRIPTION

DRAWING:

SHEET: 17 OF 20


### **CONSTRUCTION NOTES:**

61 FILL PLACED ON SLOPES GREATER THAN 3 HORIZONTAL TO 1 VERTICAL SHALL BE KEYED INTO THE UNDISTURBED GROUND WITH HORIZONTAL BENCHES HAVING A VERTICAL FACE APPROXIMATELY 1 FOOT IN HEIGHT. SLOPE EACH BENCH TO DRAIN.



WATER TANK SITE CROSS SECTION - STA. 0+00 TO 1+50 HORIZONTAL SCALE: 1" = 20'

VERTICAL SCALE: 1" = 5'

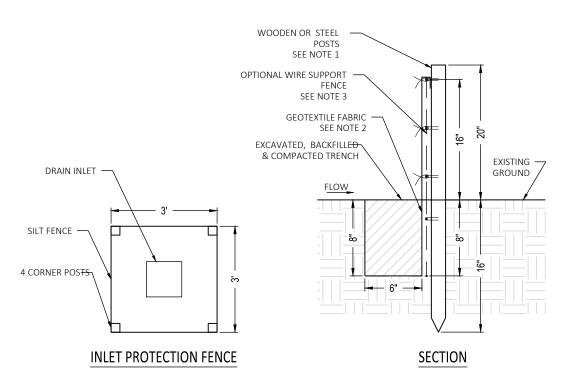

### NOTES:

Plot Date:8/13/2025 9:12 PM Plotted By: Dylan Jones Path: Z:\DOCUMENTS\PROJECTS\2024\D24013 SYRINGA ESTATES (DEERFIELD)\CAD\PLAN SHEETS\D24013 - C1.15\_ERO DETAILS.

- HARDWOOD POSTS SHALL HAVE A MINIMUM CROSS SECTIONAL AREA OF 3 SQUARE INCHES. STEEL POSTS SHALL BE STANDARD "T" OR "U" SECTION WEIGHING NOT LESS THAN 1 POUND PER LINEAR FOOT.
- 2. GEOTEXTILES MEETING THE FOLLOWING ARE ACCEPTABLE:

PROPERTY	TEST METHOD	MINIMUM AVERAGE	
GRAB TENSILE STRENGTH	ASTM D4632	90 LB	
GRAB ELONGATION (@ 45 LB MIN)	ASTM D4632	50% MAX	
PERMITTIVITY	ASTM D4491	0.05 SEC-1	
APPARENT OPENING SIZE	ASTM D4751	#20 OR FINER	
ULTRAVIOLET STABILITY RETAINED	ASTM D4355	70% STRENGTH @ 150 HRS	

- 3. OPTIONAL WIRE SUPPORT FENCE SHALL BE A MINIMUM OF 14.5 GAUGE WELDED WIRE W/6" MESH SPACING.
- IF OPTIONAL WIRE SUPPORT FENCE IS USED, ATTACH TO GEOTEXTILE W/TIE WIRES OR RINGS AT MINIMUM 24" SPACING AND ATTACH WIRE FENCE TO POSTS W/ STAPLES, TIE WIRES OR RINGS IN 3 PLACES.
- IF OPTIONAL WIRE SUPPORT FENCE IS NOT USED, ATTACH GEOTEXTILE DIRECTLY TO POSTS W/ STAPLES, TIE WIRES OR RINGS IN 3 PLACES. WHERE JOINTS IN THE GEOTEXTILE FABRIC ARE REQUIRED, SPLICE ONLY AT A SUPPORT POST, WITH A MINIMUM 6 INCH, FOLDED OVERLAP. INSPECT SILT FENCE PERIODICALLY FOR DAMAGE AND REMOVE SEDIMENT WHEN IT REACHES ONE-HALF THE HEIGHT OF THE FENCE.

**SILT FENCE** 


NOT TO SCALE



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BONNER COUNTY, ID DEERFIELD

EROSION AND SEDIMENT CONTROL DETAILS

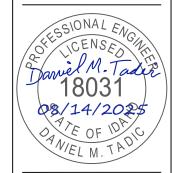

### **CONSTRUCTION DOCUMENTS**

SCALE: (11X17 ONLY)

DWG:D24013 - C1.15\_ERO DETAILS.DWG

PROJECT NO: D24013 DJJ/DMH DRAWN BY: CHECKED BY: DMT

DATF. AUGUST 2025

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REVISIONS

NO. DATE BY DESCRIPTION

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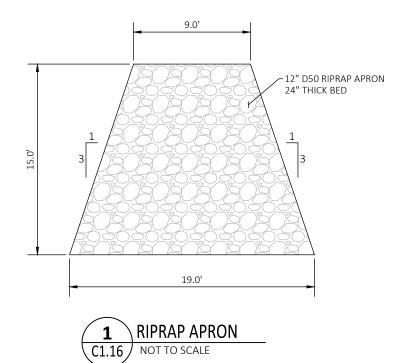
**DRAWING:** 

SHEET: 18 OF 20

### NOTES:


1.	RIPRAP GEOTEXTILES MEETING THE FOLLOWING	G ARE ACCEPTABLE:	
	PROPERTY	TEST METHOD	MINIMUM AVERAGE
	GRAB TENSILE STRENGTH, LB	ASTM D4632	315
	GRAB ELONGATION, %	ASTM D4632	MAX 50%
	PUNCTURE STRENGTH, LB	ASTM D6241	600
	TRAPEZOIDAL TEAR, LB	ASTM D4533	110
	APPARENT OPENING SIZE, STANDARD SIEVE	ASTM D4751	#40 OR FINER
	PERMITTIVITY, SEC-1	ASTM D4491	0.7
	ULTRAVIOLET RADIATION STABILITY	ASTM D4355	70% STRENGTH @ 150 HRS

2. RIPRAP GRADATION SHALL FOLLOW FHWA CLASS 3 OR APPROVED EQUAL.



### **NOTES:**

- 1. RESTRICT HEAVY EQUIPMENT AND TRAFFIC FROM TRAVELING OVER INFILTRATION AREAS TO MINIMIZE COMPACTION.
- CUT THE GEOTEXTILE FABRIC WIDTH TO INCLUDE SUFFICIENT MATERIAL TO CONFORM TO TRENCH IRREGULARITIES AND A 1 FOOT MINIMUM TOP OVERLAP.
- 3. WHEN OVERLAPS ARE REQUIRED BETWEEN ROLLS OF GEOTEXTILE FABRIC, OVERLAP THE UPSTREAM ROLL A MINIMUM OF 2 FEET OVER THE DOWNSTREAM ROLL.
- 4. TILL THE NATIVE BACKFILL TO CREATE A SOIL GRADATION ZONE. BACKFILL THE REMAINDER OF THE NATIVE GROUND TO FINAL GRADE.
- 5. PERFORM MAINTENANCE IN ACCORDANCE WITH BEST PRACTICES.

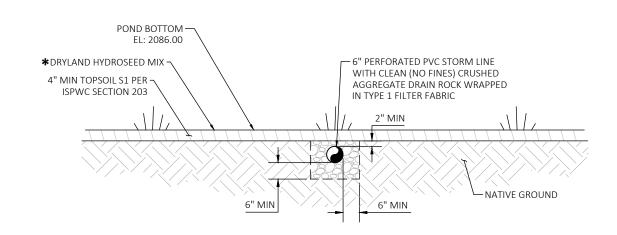



### DRYLAND HYDROSEED MIX


30% CREEPING RED FESCUE 30% CHENINGS FESCUE 25% HARD FESCUE 15% SHEEP FESCUE SEE RATE AT 2-4 LBS/SF



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**DEERFIELD**BONNER COUNTY, ID

STORMWATER DETAILS

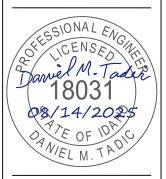

# CONSTRUCTION DOCUMENTS

1" SCALE: (11X17 ONLY)

DWG: D24013 - C1.16\_STORM POND DETAILS.DWG
PROJECT NO: D24013

DRAWN BY: DJJ/DMH
CHECKED BY: DMT
DATE: AUGUST 2025

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REVISIONS

NO. DATE BY DESCRIPTION

C1 16


DRAWING:

SHEET: 19 OF 20

Plot Date:8/13/2025 9:09 PM Plotted By: Dylan Jones Path: 2:\DOCUMENTS\PROJECTS\2024\D24013 SYRINGA ESTATES (DEERFIELD)\CAD\PLAN SHEETS\D24013 - C1.16\_STORM POND DETAILS.DWG


**ABOVE NATURAL GROUND** 

# DIAMETER 'D': MECHANICAL COMPACTED BACKFILL, PLACE IN 6" LIFTS HAND TAMPED NATURAL GROUND SHAPE TO FIT PIPE BELOW NATURAL GROUND

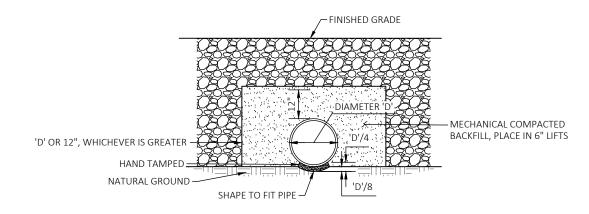

**ON NATURAL GROUND** 

Plot Date:8/13/2025 9:07 PM Plotted By: Dylan Jones Path: ZxDocUMENTS\PROJECTS\2024\D24013 SYRINGA ESTATES (DEERFIELD)\CAD\PLAN SHEETS\D24013 - C1.17\_SD DETAILS

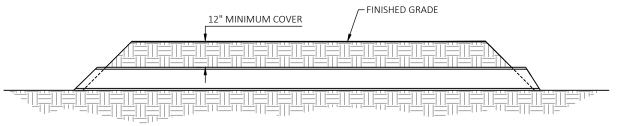

### **CULVERT CROSS SECTION**

### NOTES

- 1. MINIMUM PIPE SIZE SHALL BE 12" IN DIAMETER (MIN) OR AS OTHERWISE NOTED ON THE PLANS. PIPE SHALL EXTEND A MINIMUM OF ONE FOOT BEYOND THE TOE OF FILL.
- $2. \quad \mathsf{PIPE} \ \mathsf{SHALL} \ \mathsf{BE} \ \mathsf{INSTALLED} \ \mathsf{PER} \ \mathsf{MANUFACTURER'S} \ \mathsf{SPECIFICATIONS}.$
- 3. ACCEPTABLE PIPE MATERIAL DOUBLE-WALLED CORRUGATED POLYETHYLENE PIPE WITH SMOOTH INNER LINER (CPP S) OR GALVANIZED METAL.
- 4. PROVIDE RIP-RAP AT PIPE OUTLET WHEN INDICATED ON THE PLANS.


TYPICAL CULVERT INSTALLATION NOT TO SCALE



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STORMWATER DETAILS



# CONSTRUCTION DOCUMENTS

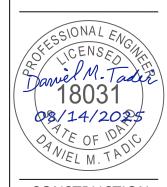1" SCALE: (11X17 ONLY)

DWG:D24013 - C1.17\_SD DETAILS.DWG

PROJECT NO: D24013
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CHECKED BY: DMT

DATE: AUGUST 2025

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C1.17

DRAWING:

SHEET: 20 OF 20

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